
ARCHITECTURAL DRAWING LIST FOR \$4.55

A100 **TITLE SHEET & LOCATION PLAN**

A110 A200 A201 A201-1 A202 A203 A205 A206	LEVEL 3 PLAN LEVEL 4 PLAN LEVEL 5-14 PLAN LEVEL 15-22 PLAN
A207	LEVEL 23 PLAN
A208	LEVEL 24 PLANTROOM PLAN
A209	ROOF PLAN
A210	PRE & POST ADAPTABLE UNIT
A300	NORTH EAST ELEVATION
A301	NORTH WEST ELEVATION
A302	SOUTH WEST ELEVATION
A303	SOUTH EAST ELEVATION
A304	SECTIONS

AREA CALCULATIONS

- LANDSCAPED AREA A800
- A801 DEEP SOIL & COMMUNAL OPEN SPACE
- A810 **GFA SHEET 1**
- **GFA SHEET 2** A811
- **CROSS VENTILATION DIAGRAMS** A820
- A821 SOLAR ACCESS DIAGRAMS

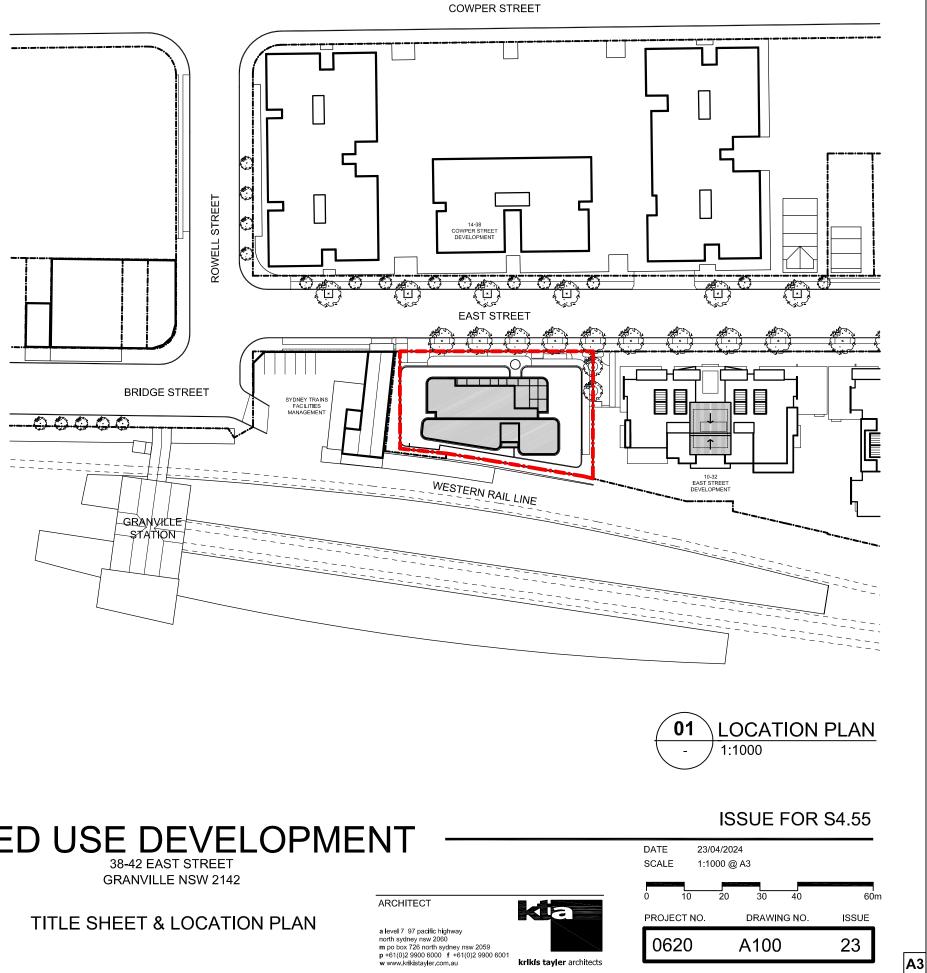

MIXED USE DEVELOPMENT


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PROPRIETOR

BURWOOD NSW 2134 Tel: 02 9744 3333


URBAN PROPERTY GROUP SUITE 110, LEVEL 1 180-186 BURWOOD ROAD





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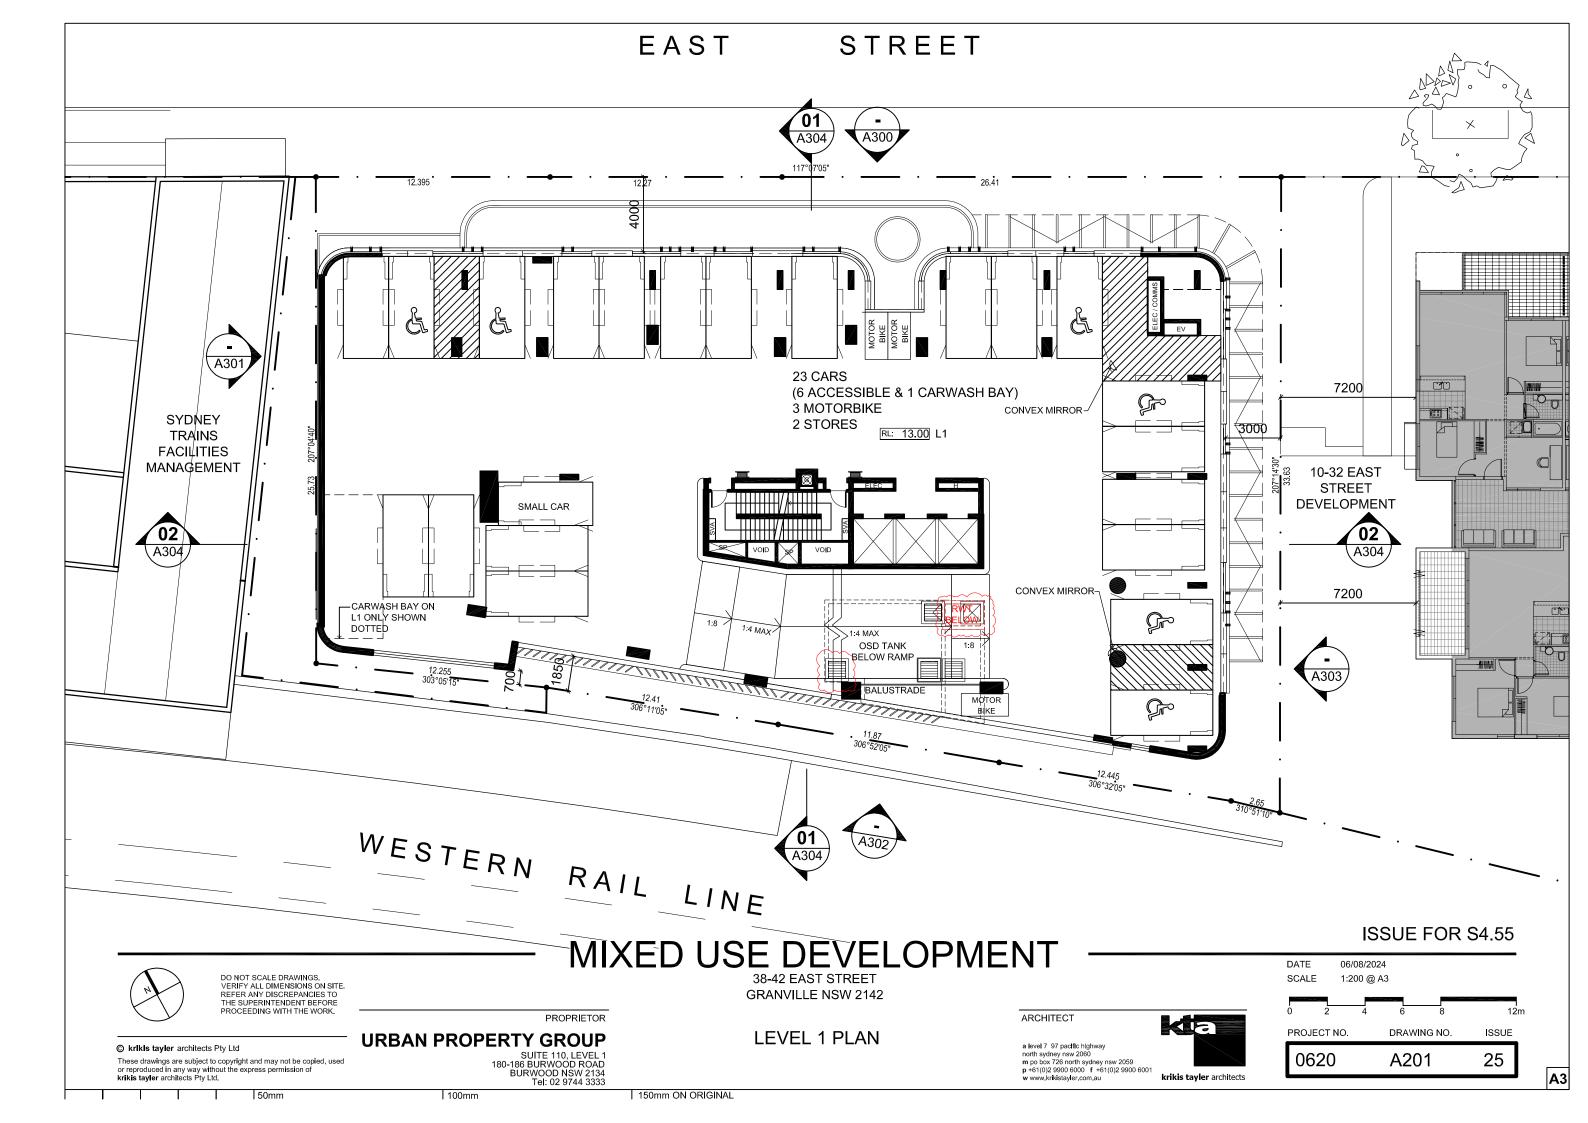
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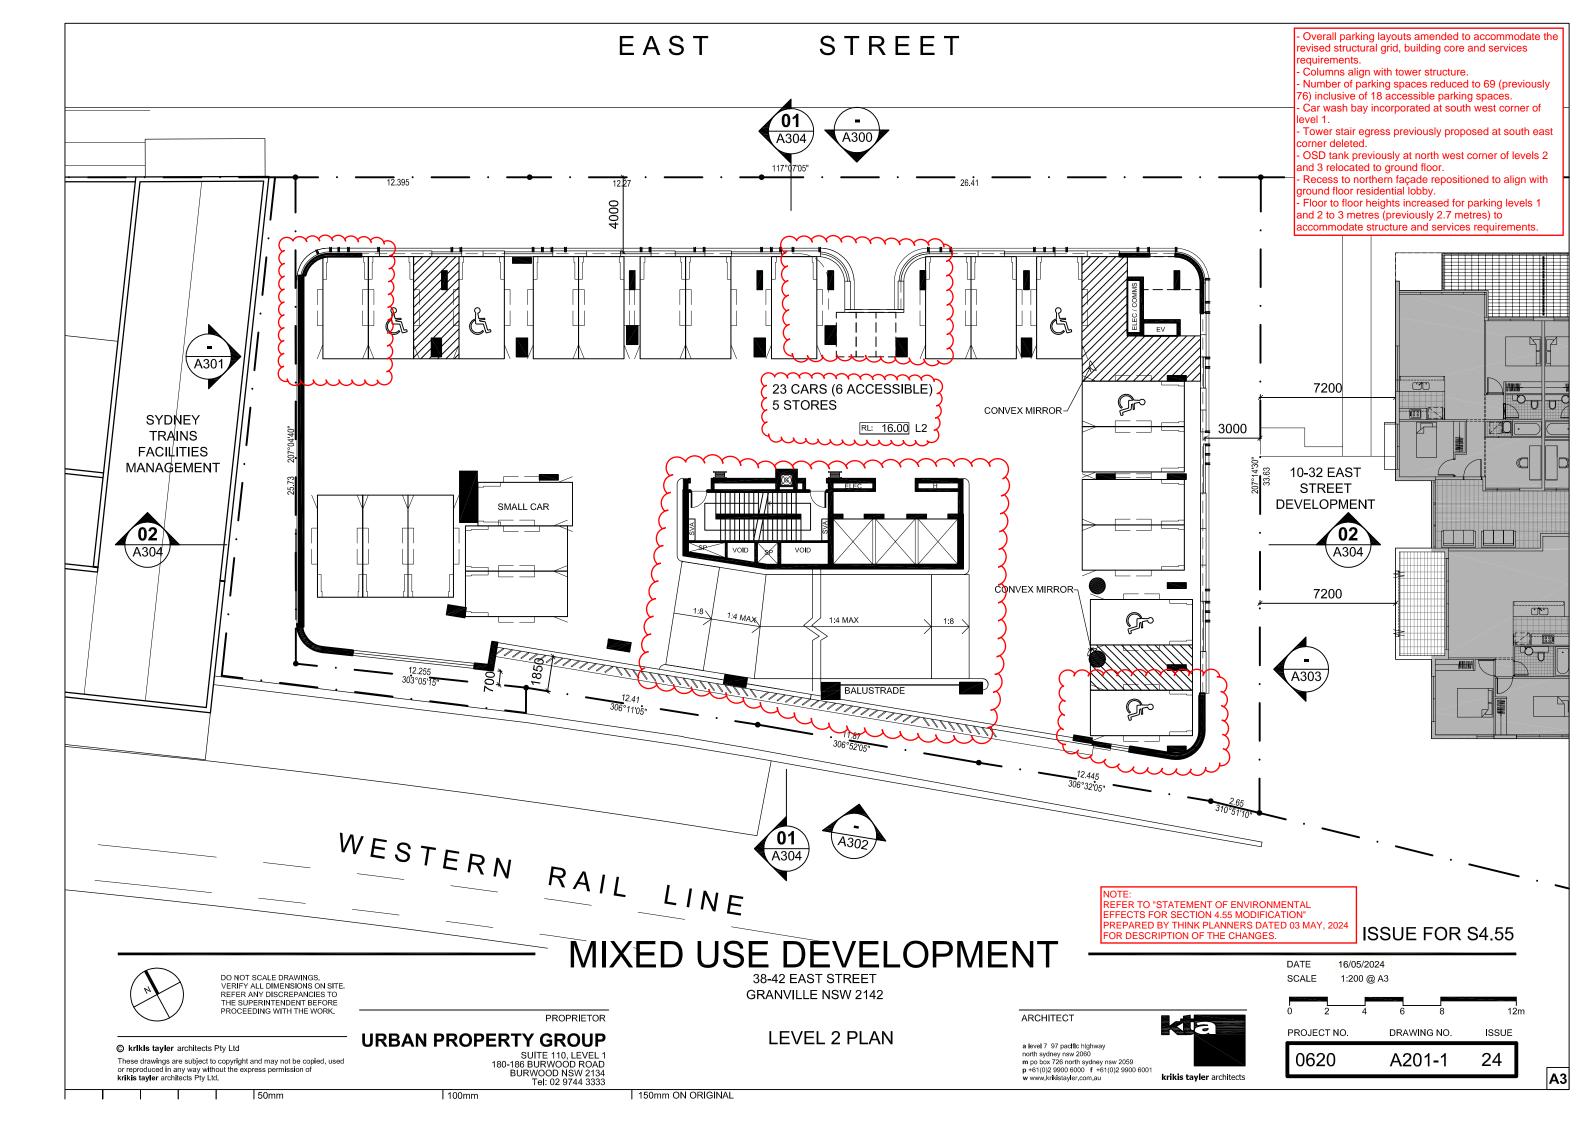
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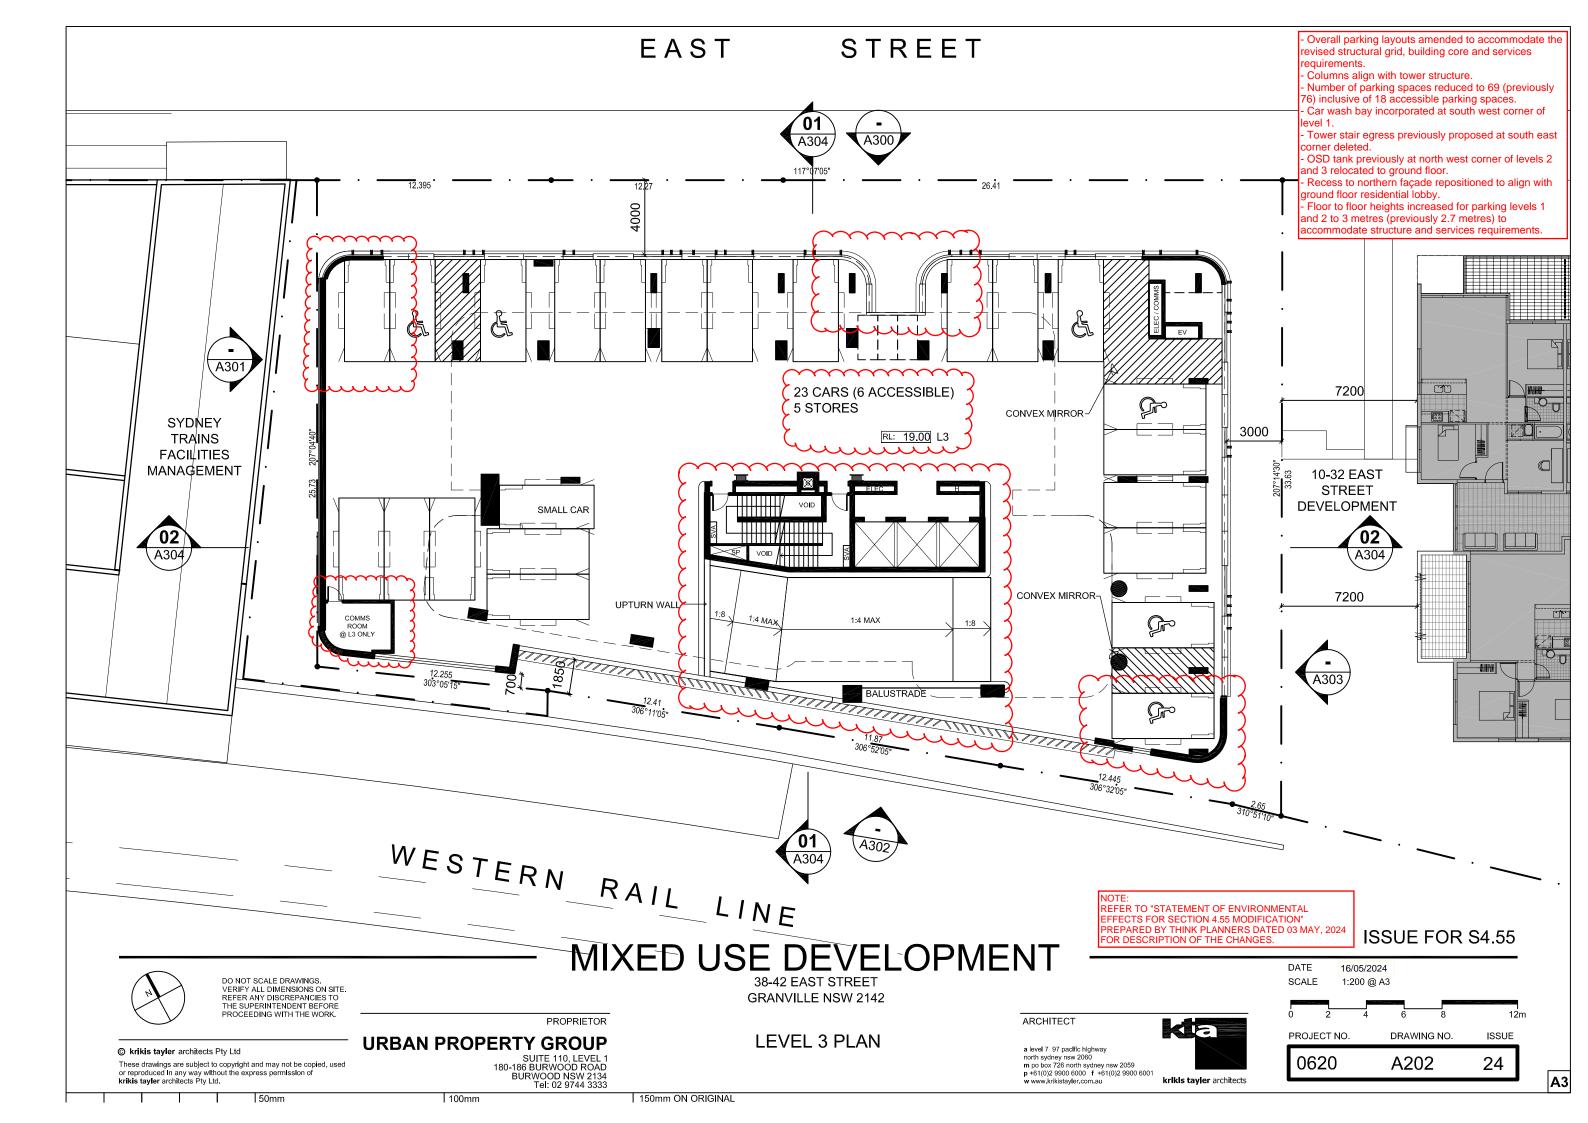


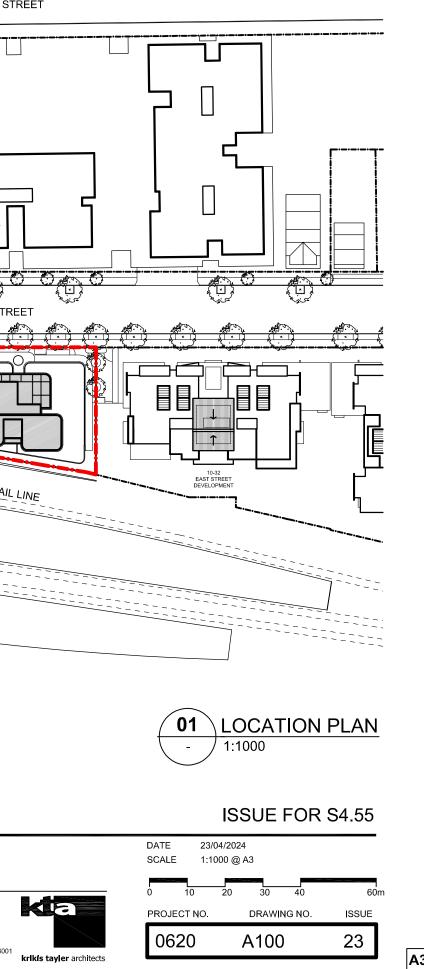





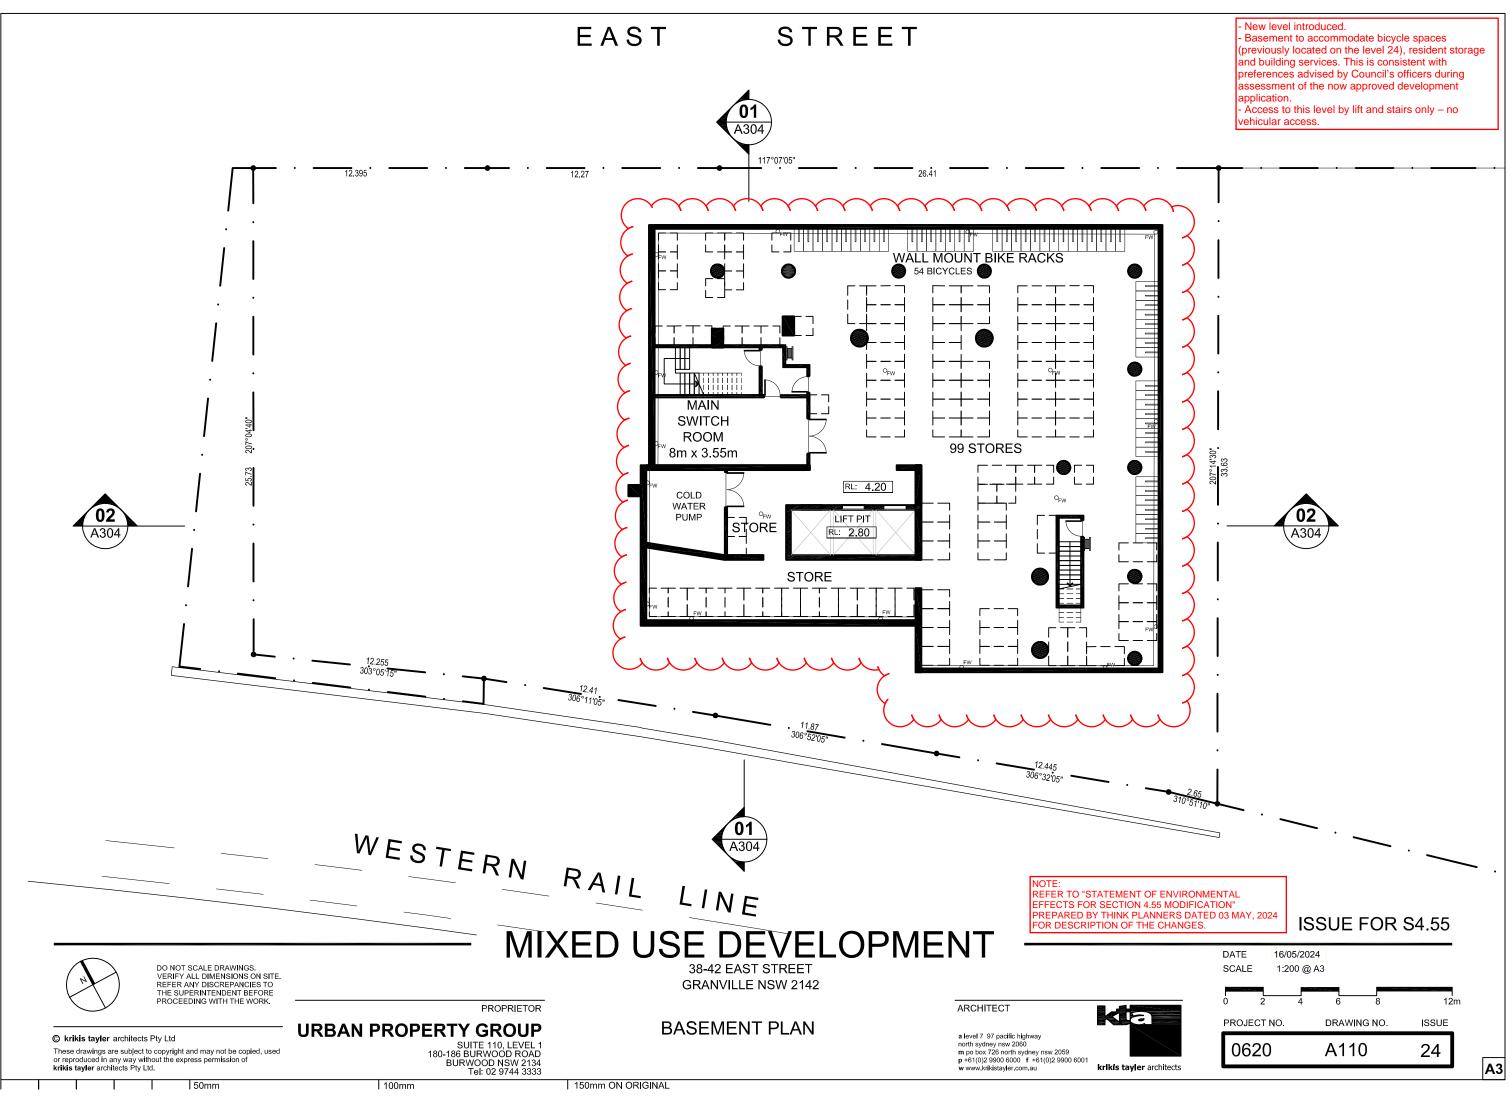


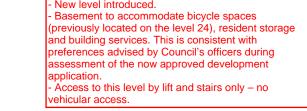


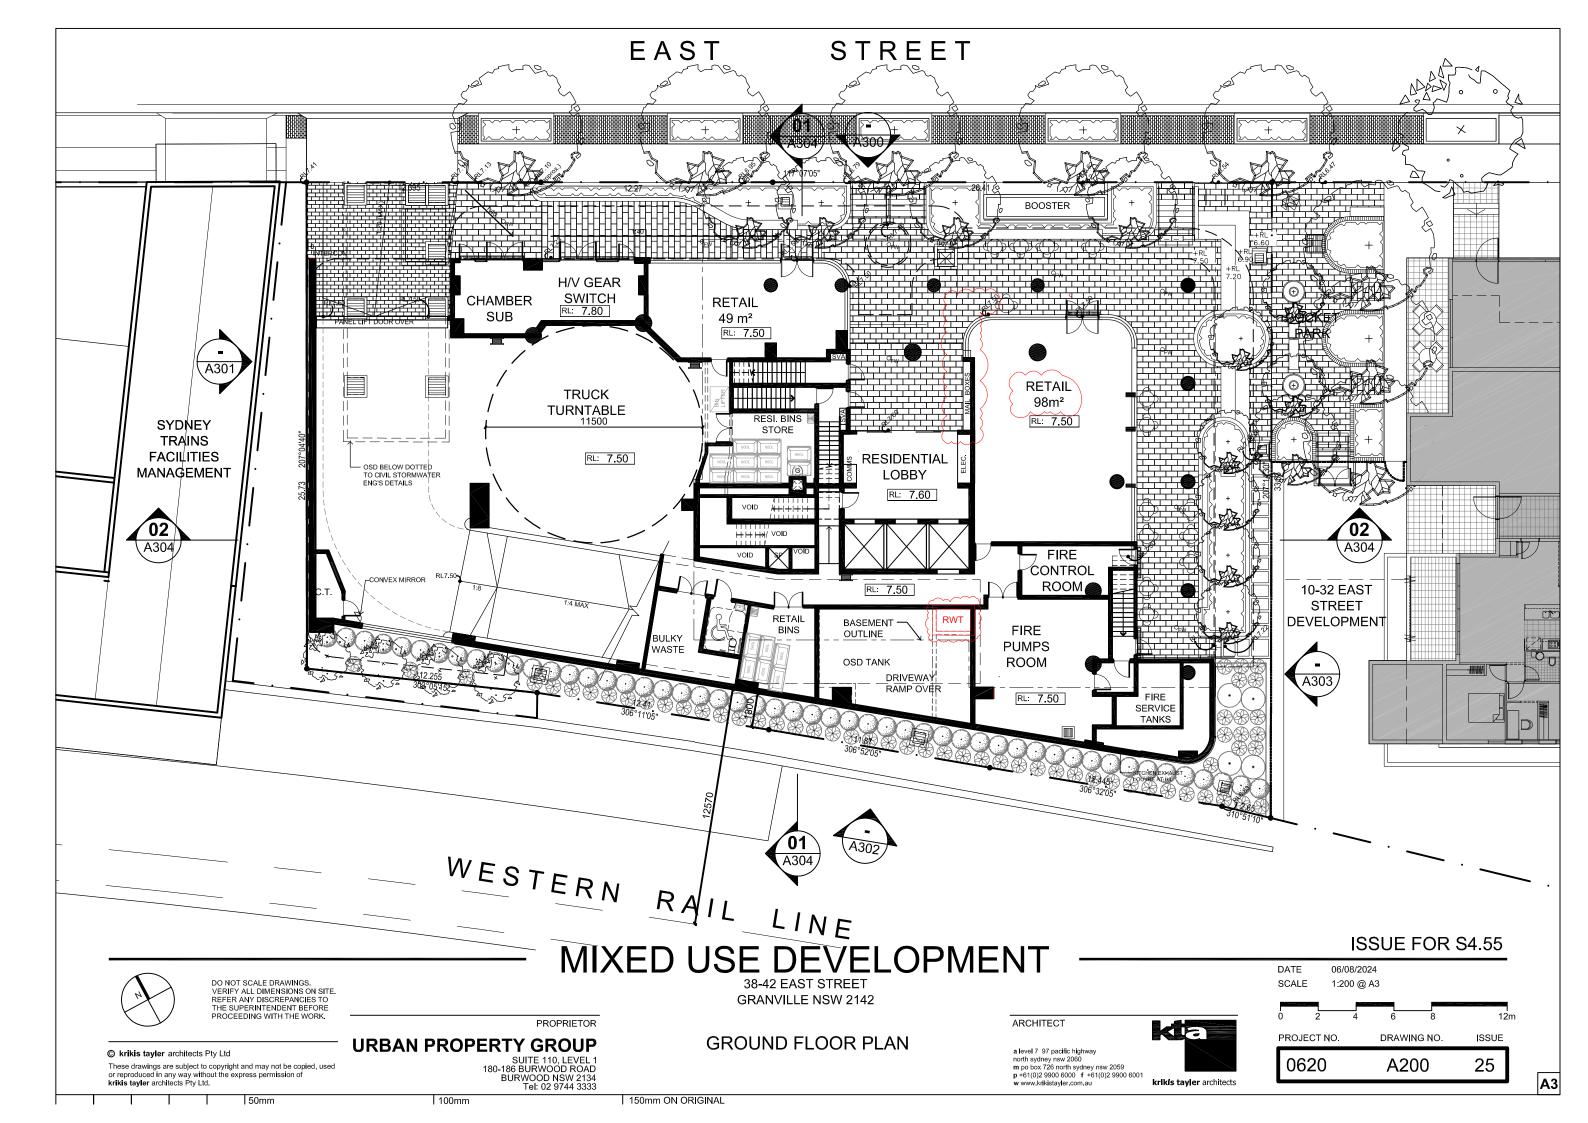


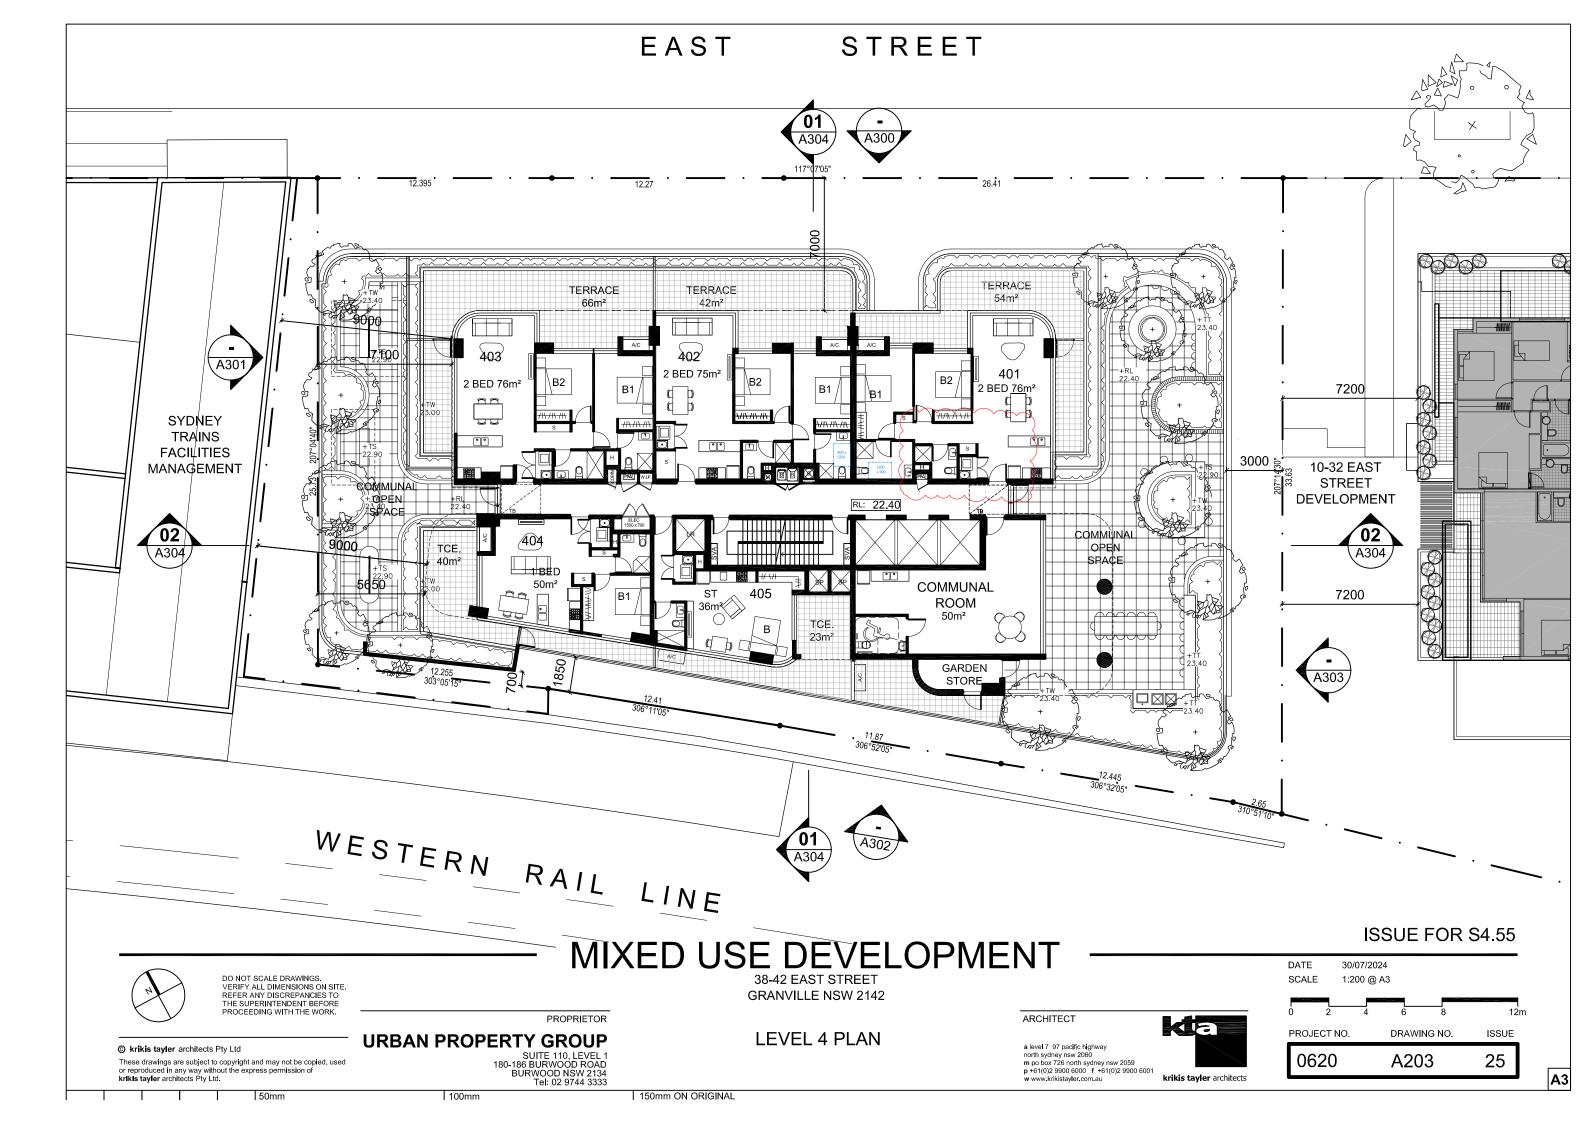


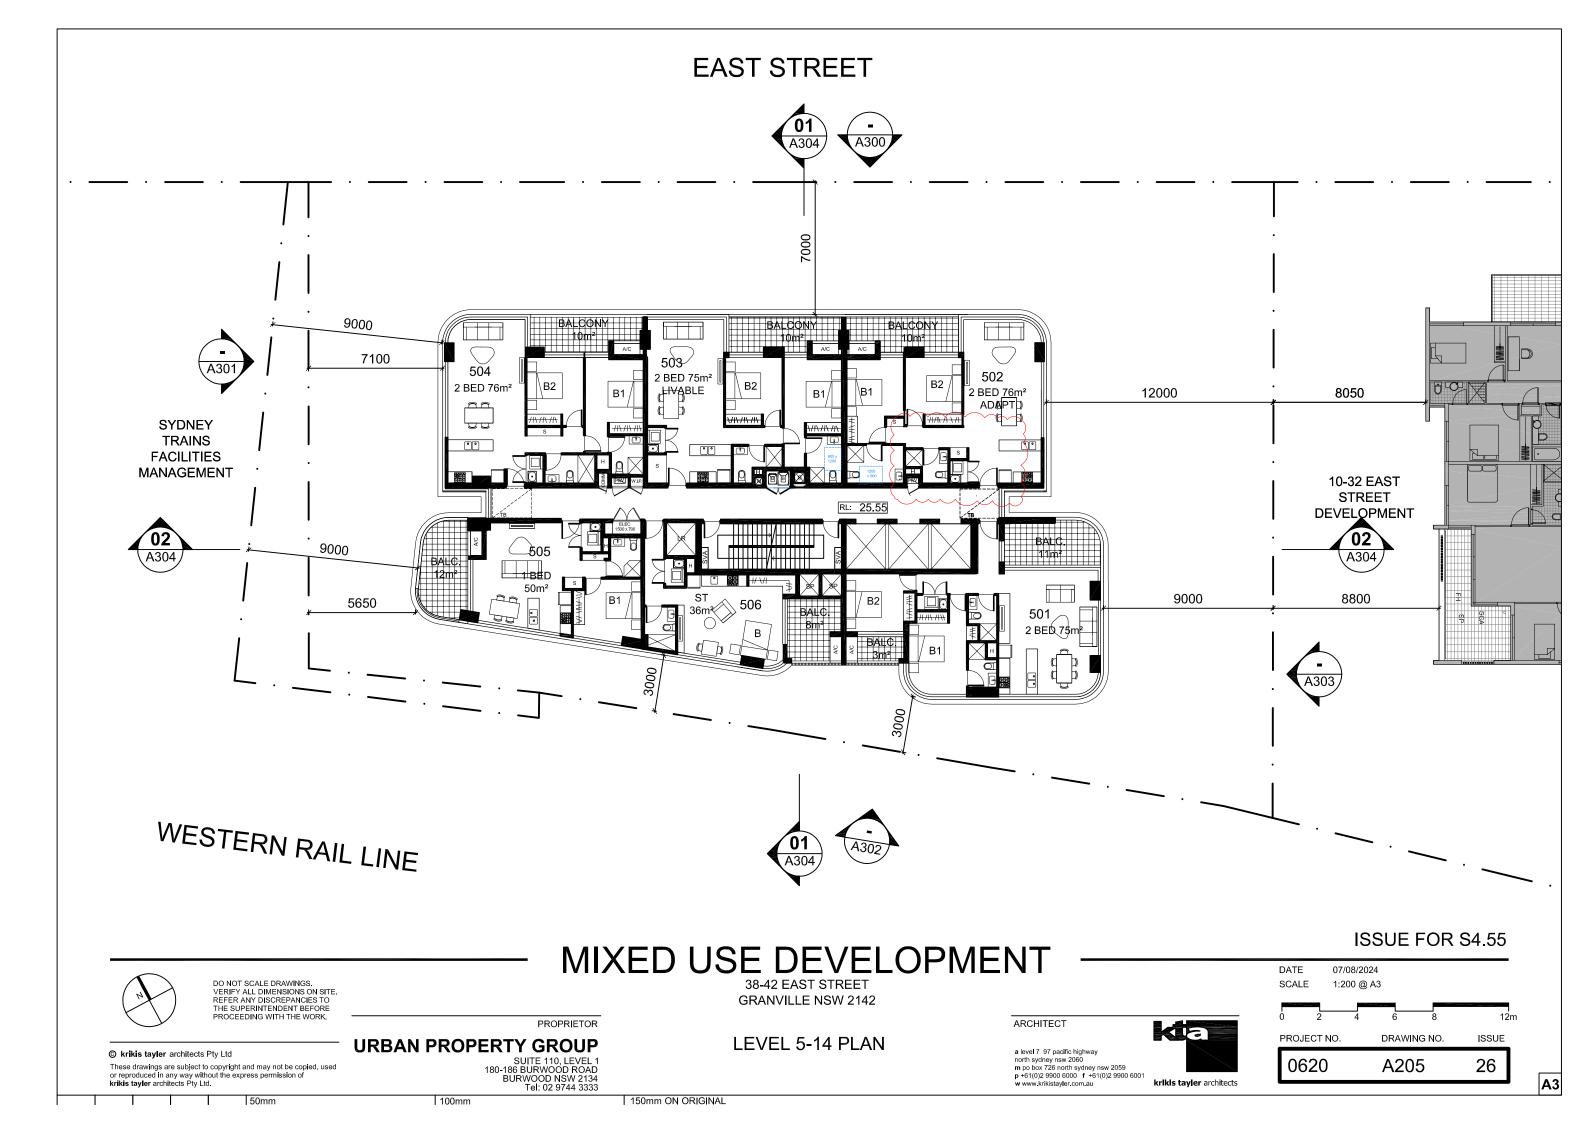


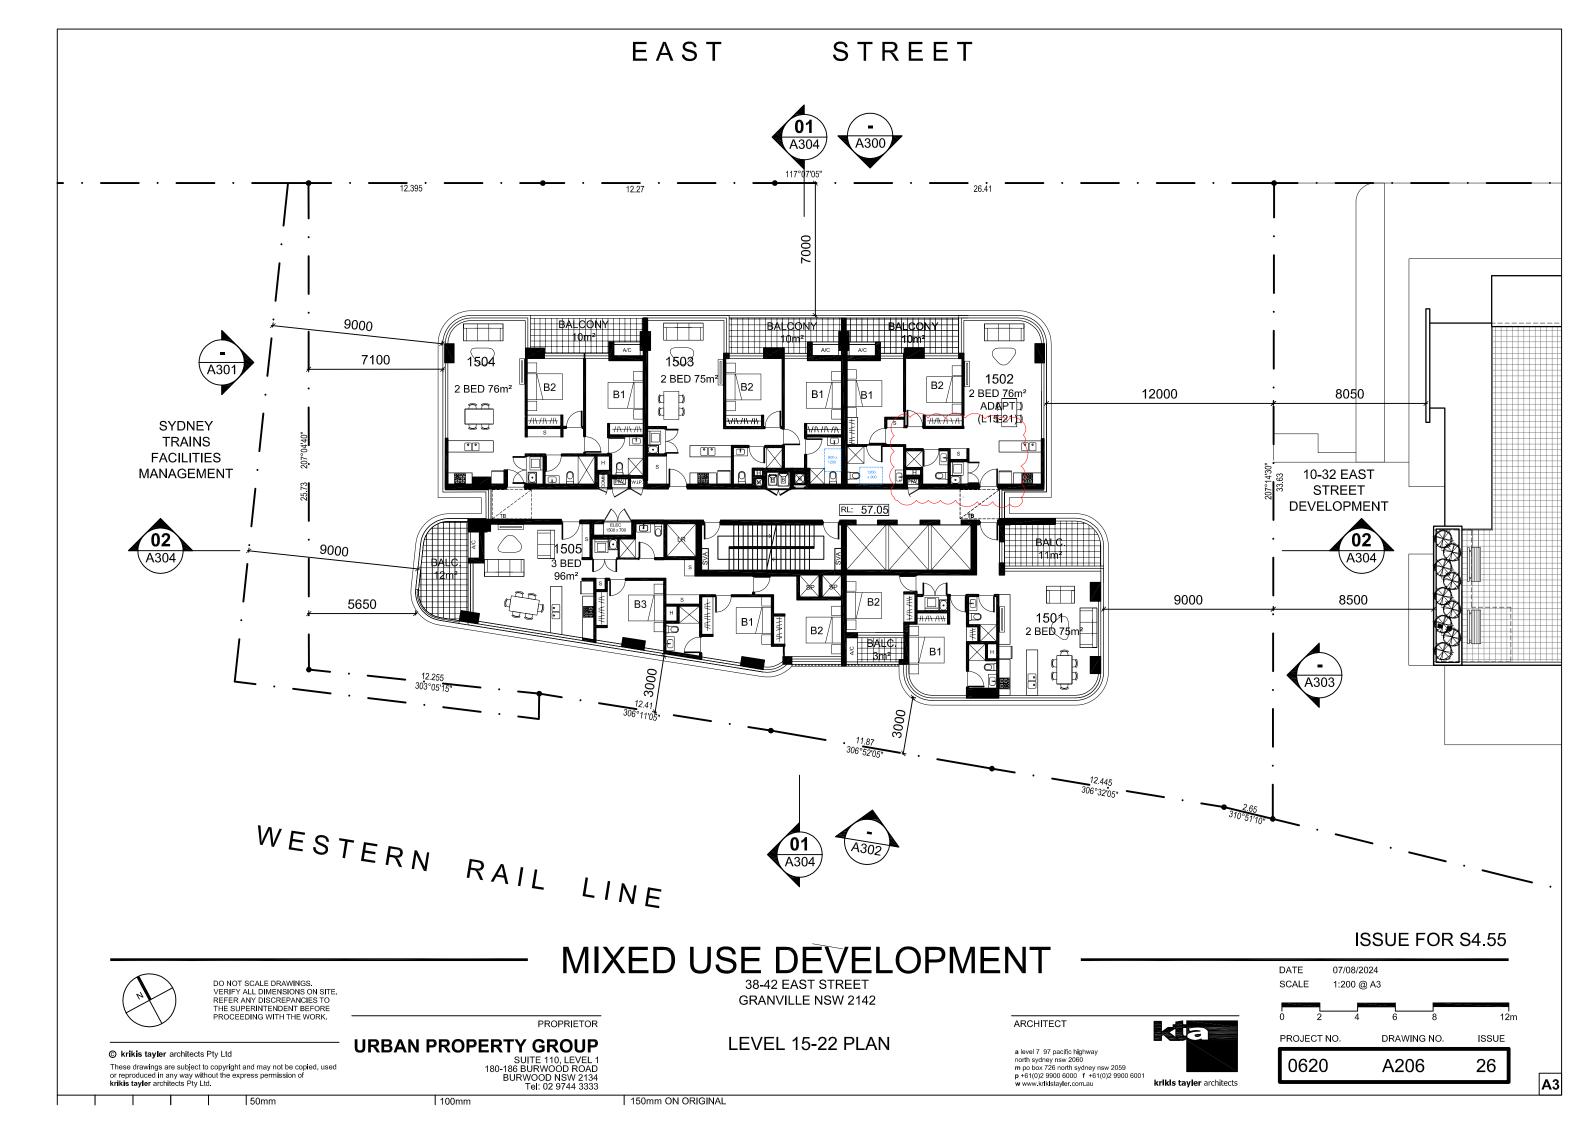

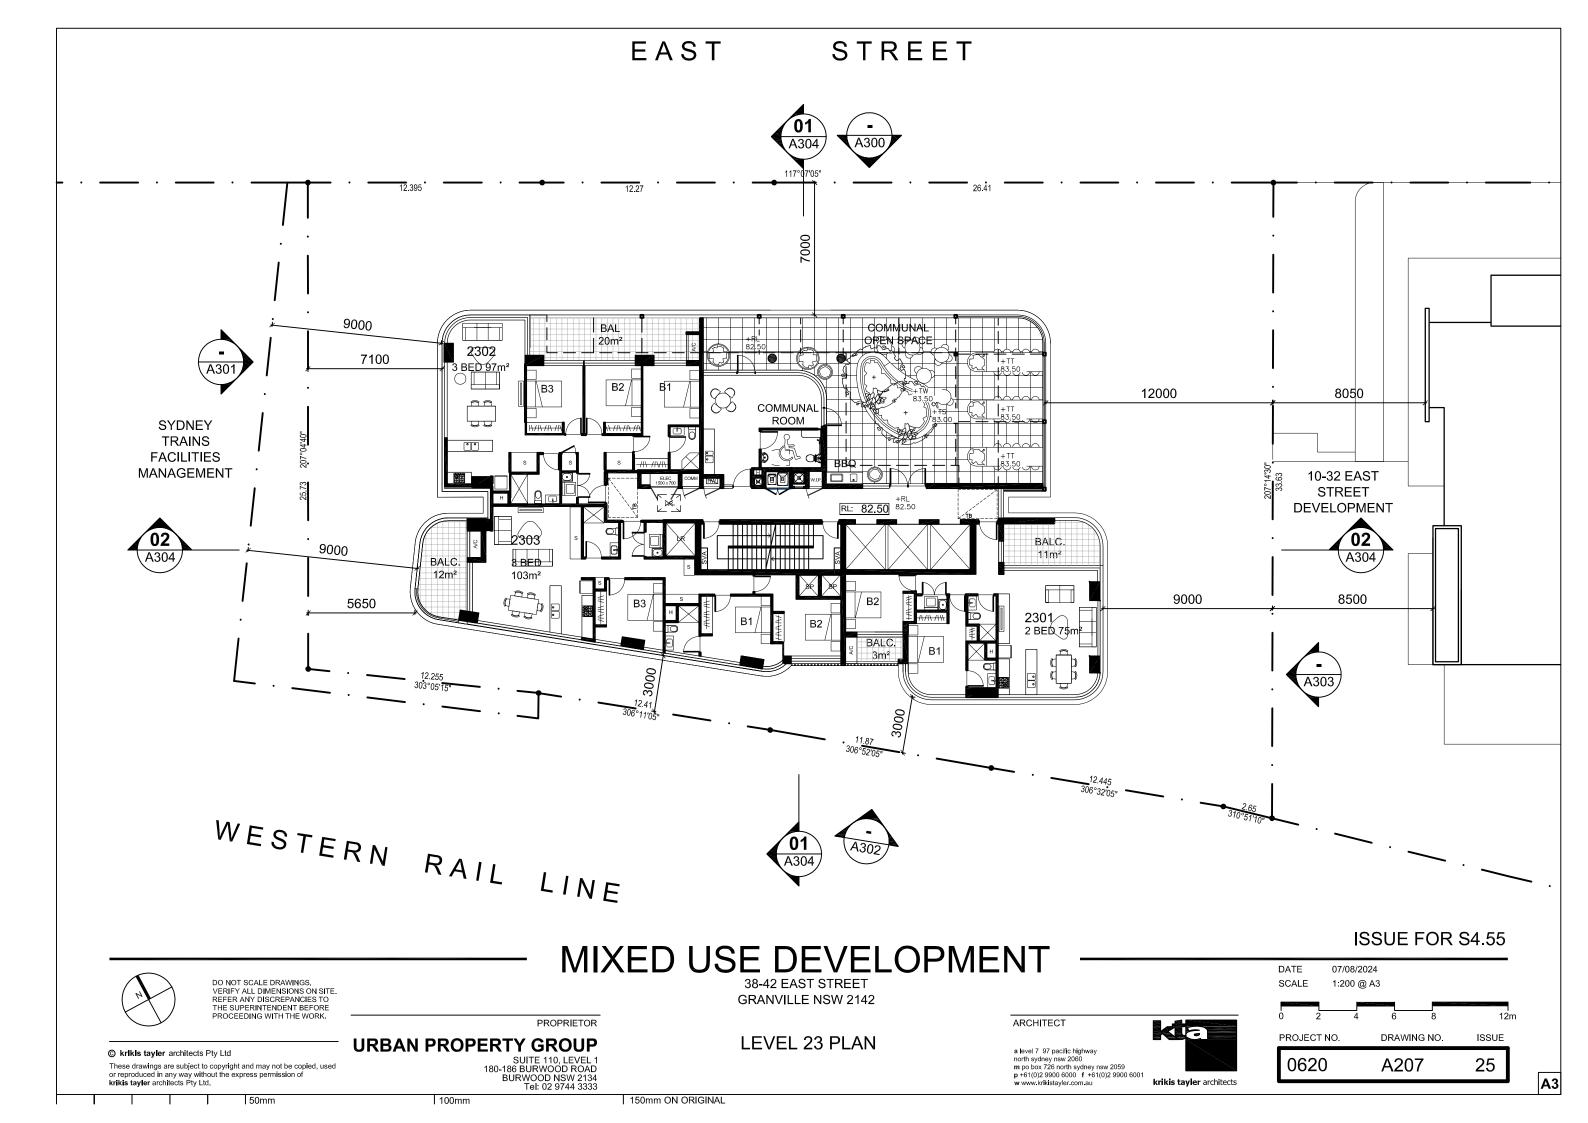

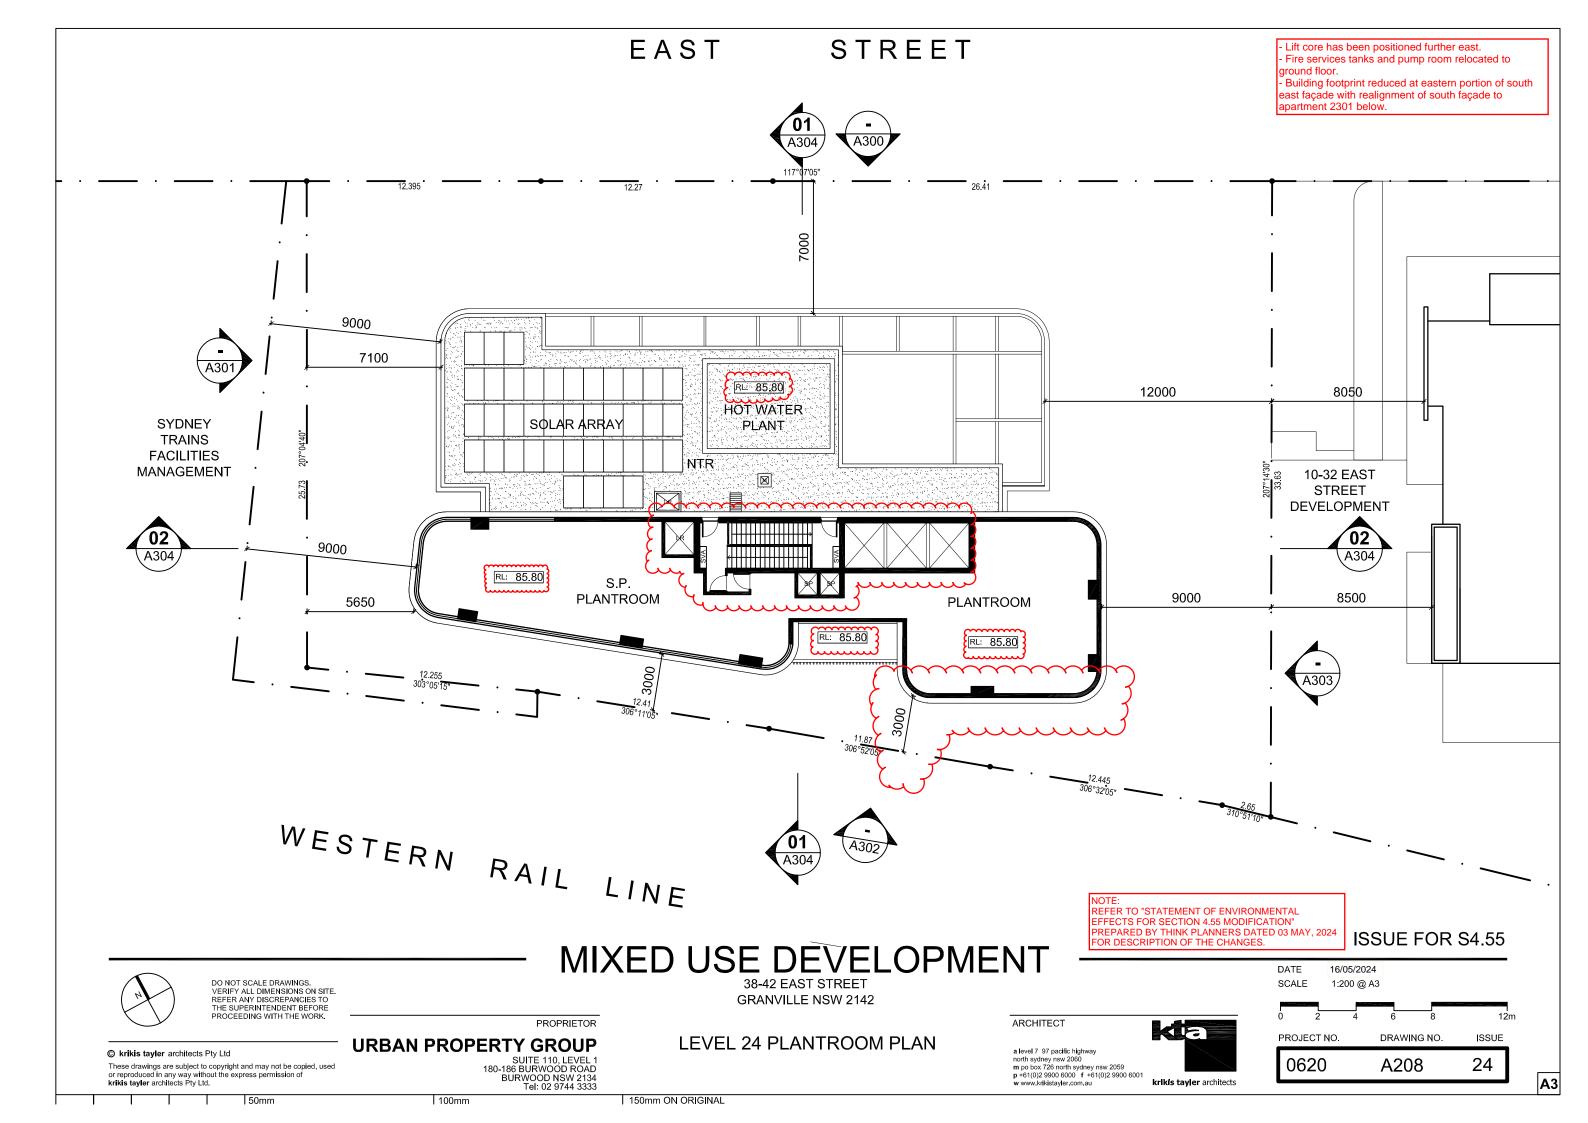

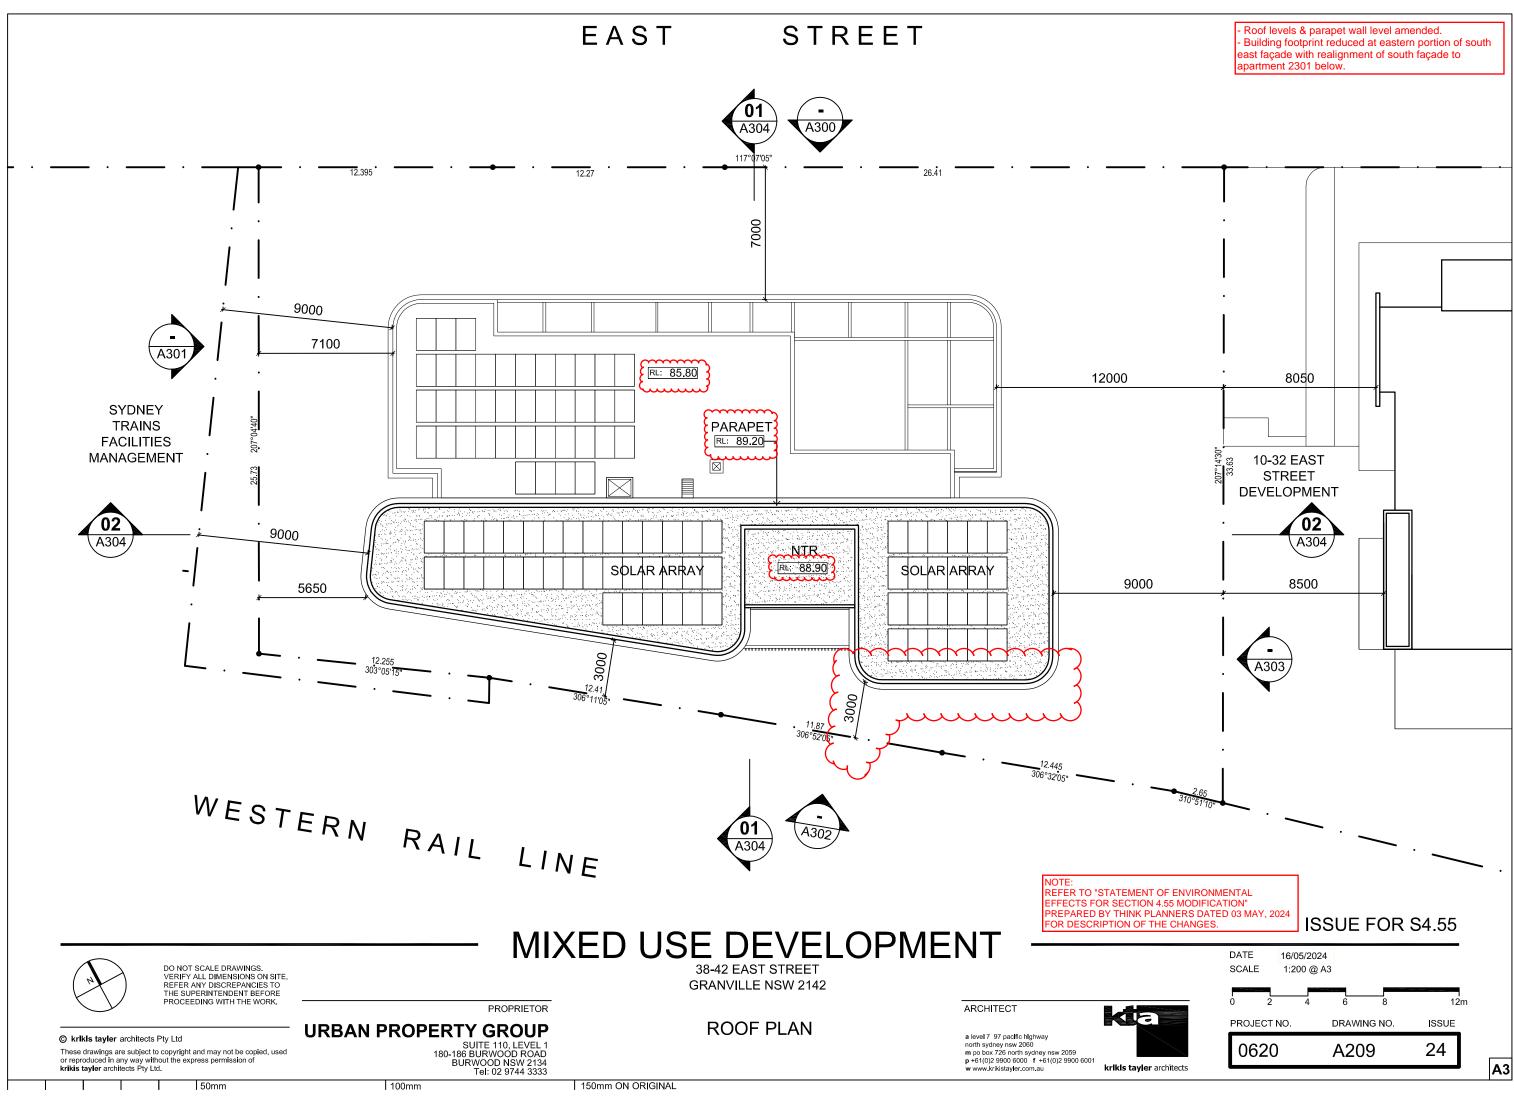

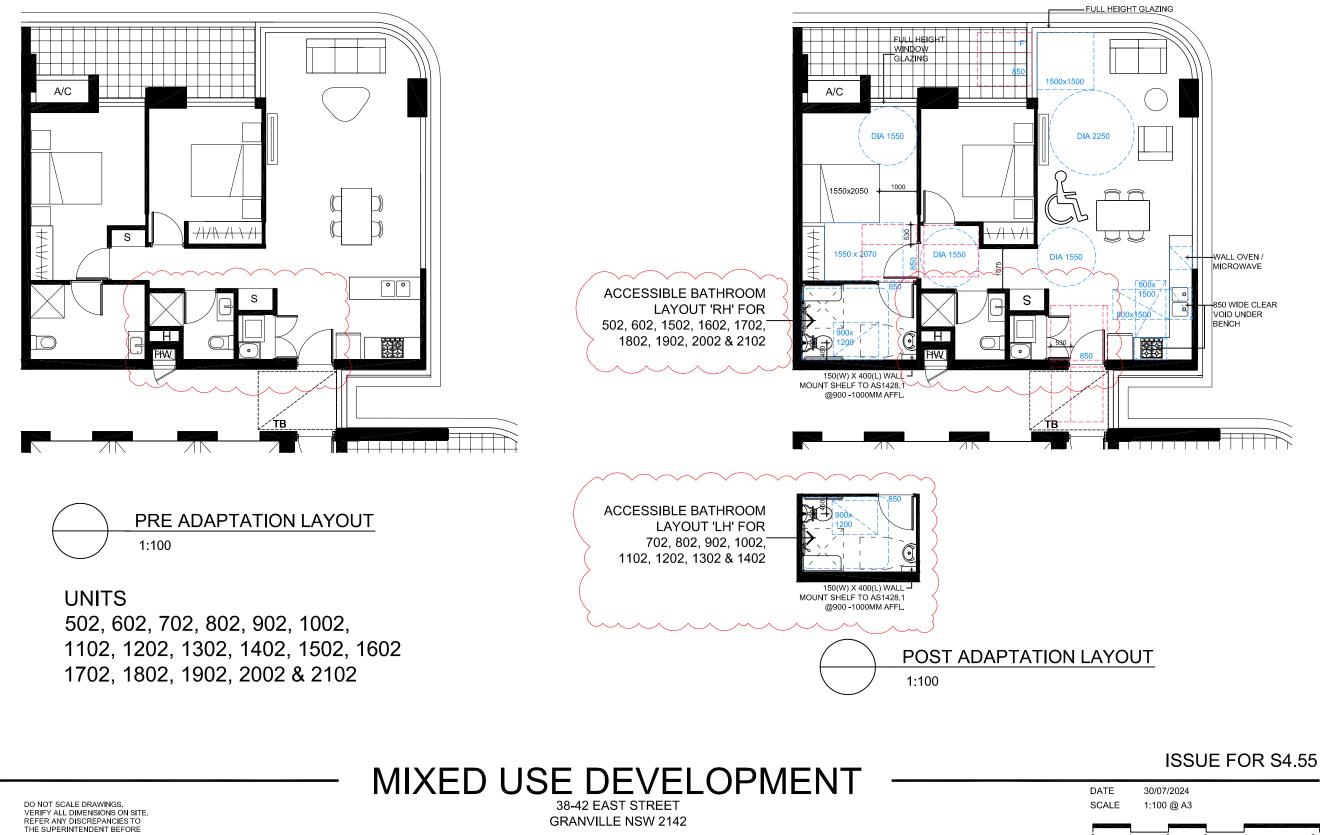

PROCEEDING WITH THE WORK.

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SUITE 110, LEVEL 1 180-186 BURWOOD ROAD BURWOOD NSW 2134 Tel: 02 9744 3333 100mm


URBAN PROPERTY GROUP

150mm ON ORIGINAL


PROPRIETOR


PRE & POST ADAPTABLE UNIT


ARCHITECT

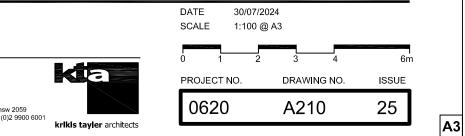


a level 7 97 pacific highway north sydney nsw 2060 m po box 726 north sydney nsw 2059 p +61(0)2 9900 6000 f +61(0)2 9900 6001 w www krikistavler com au

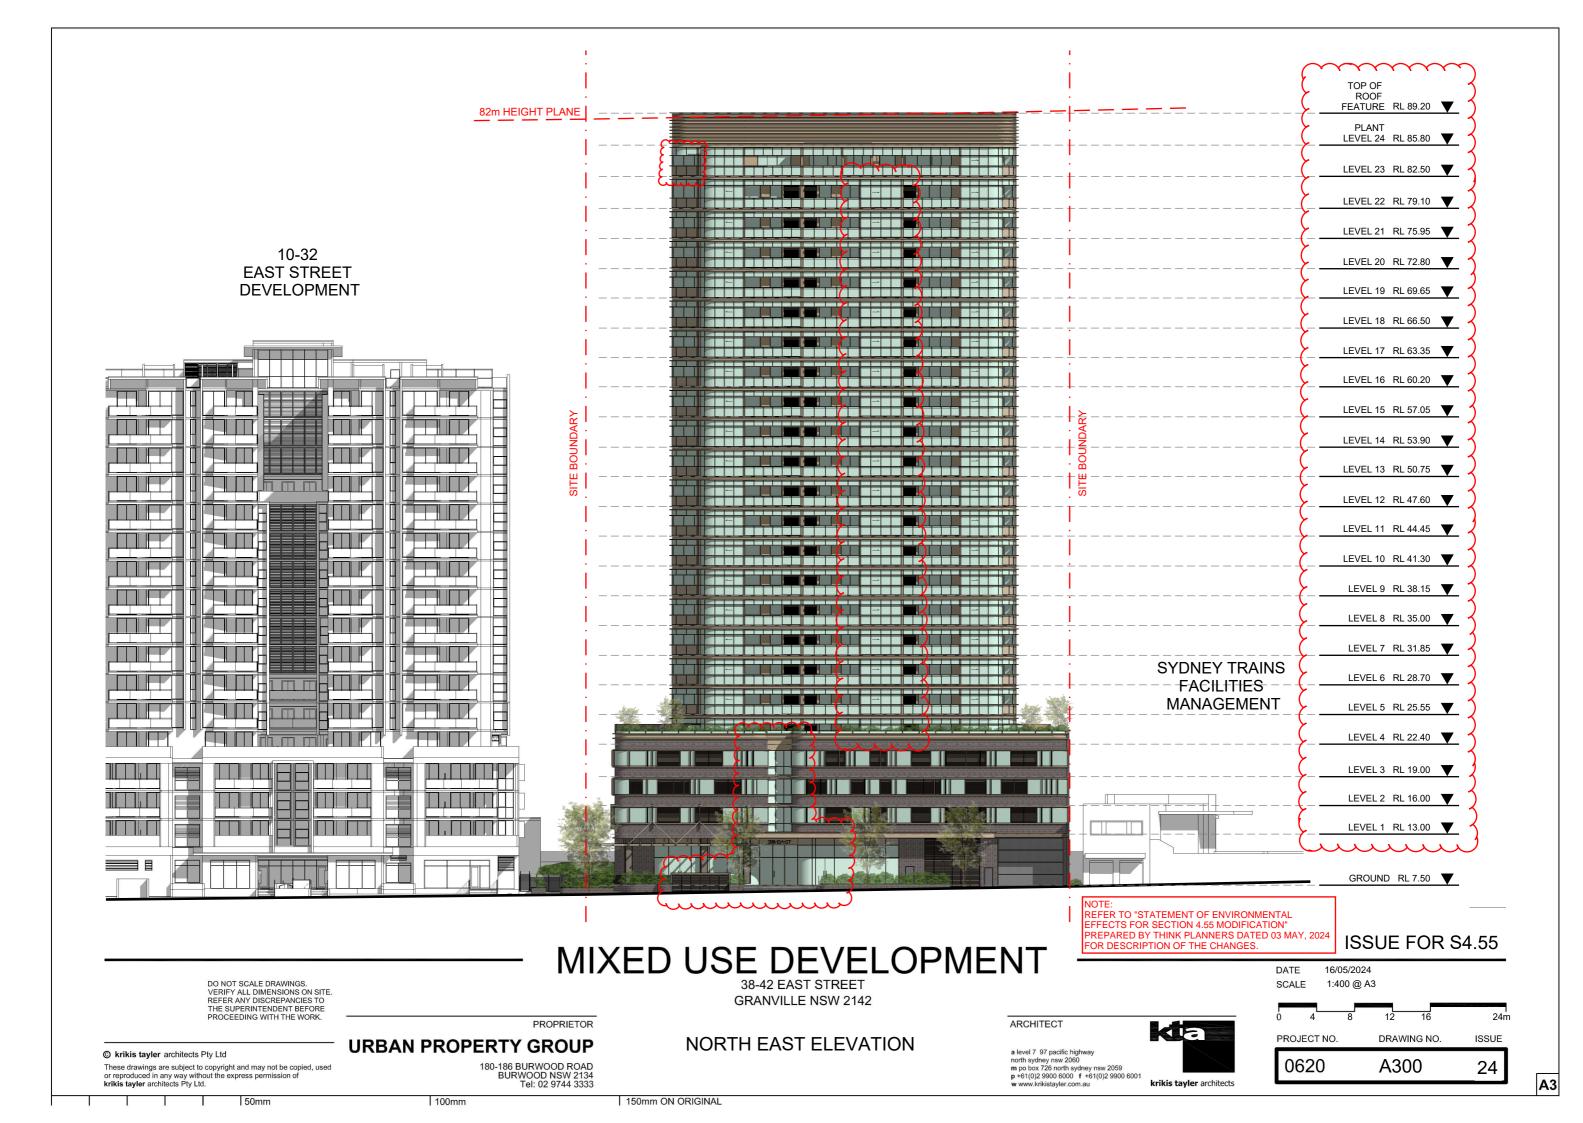

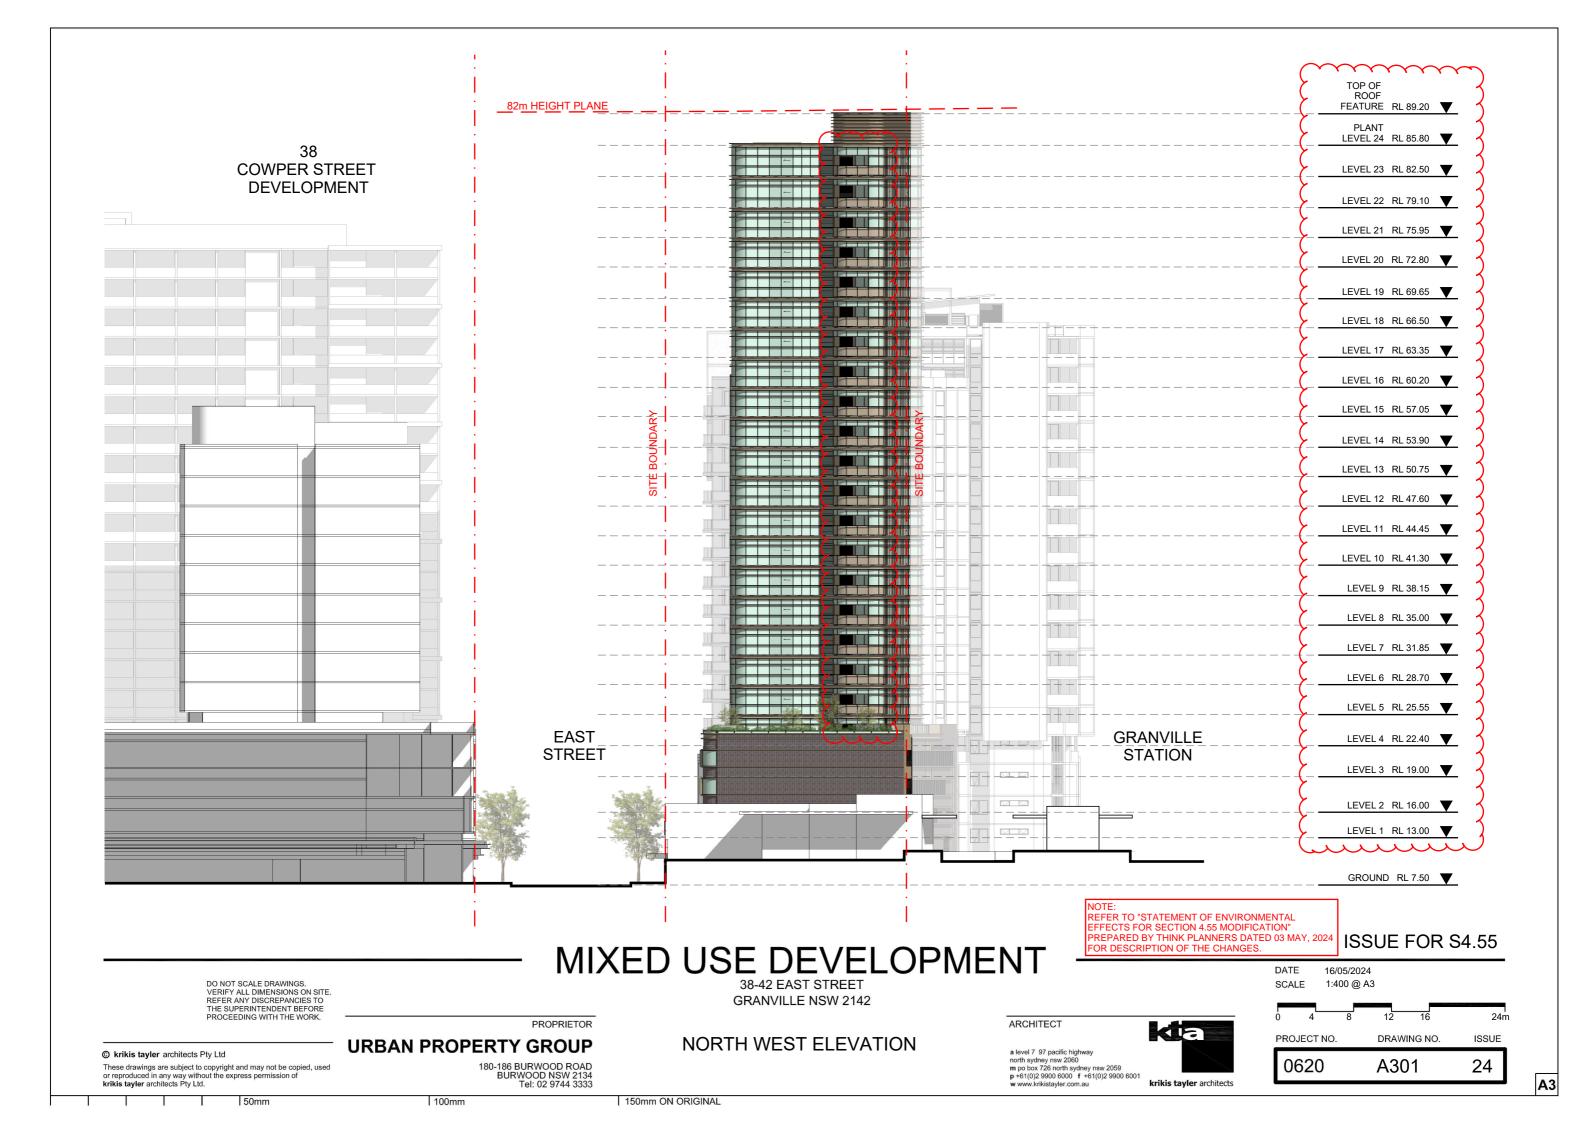

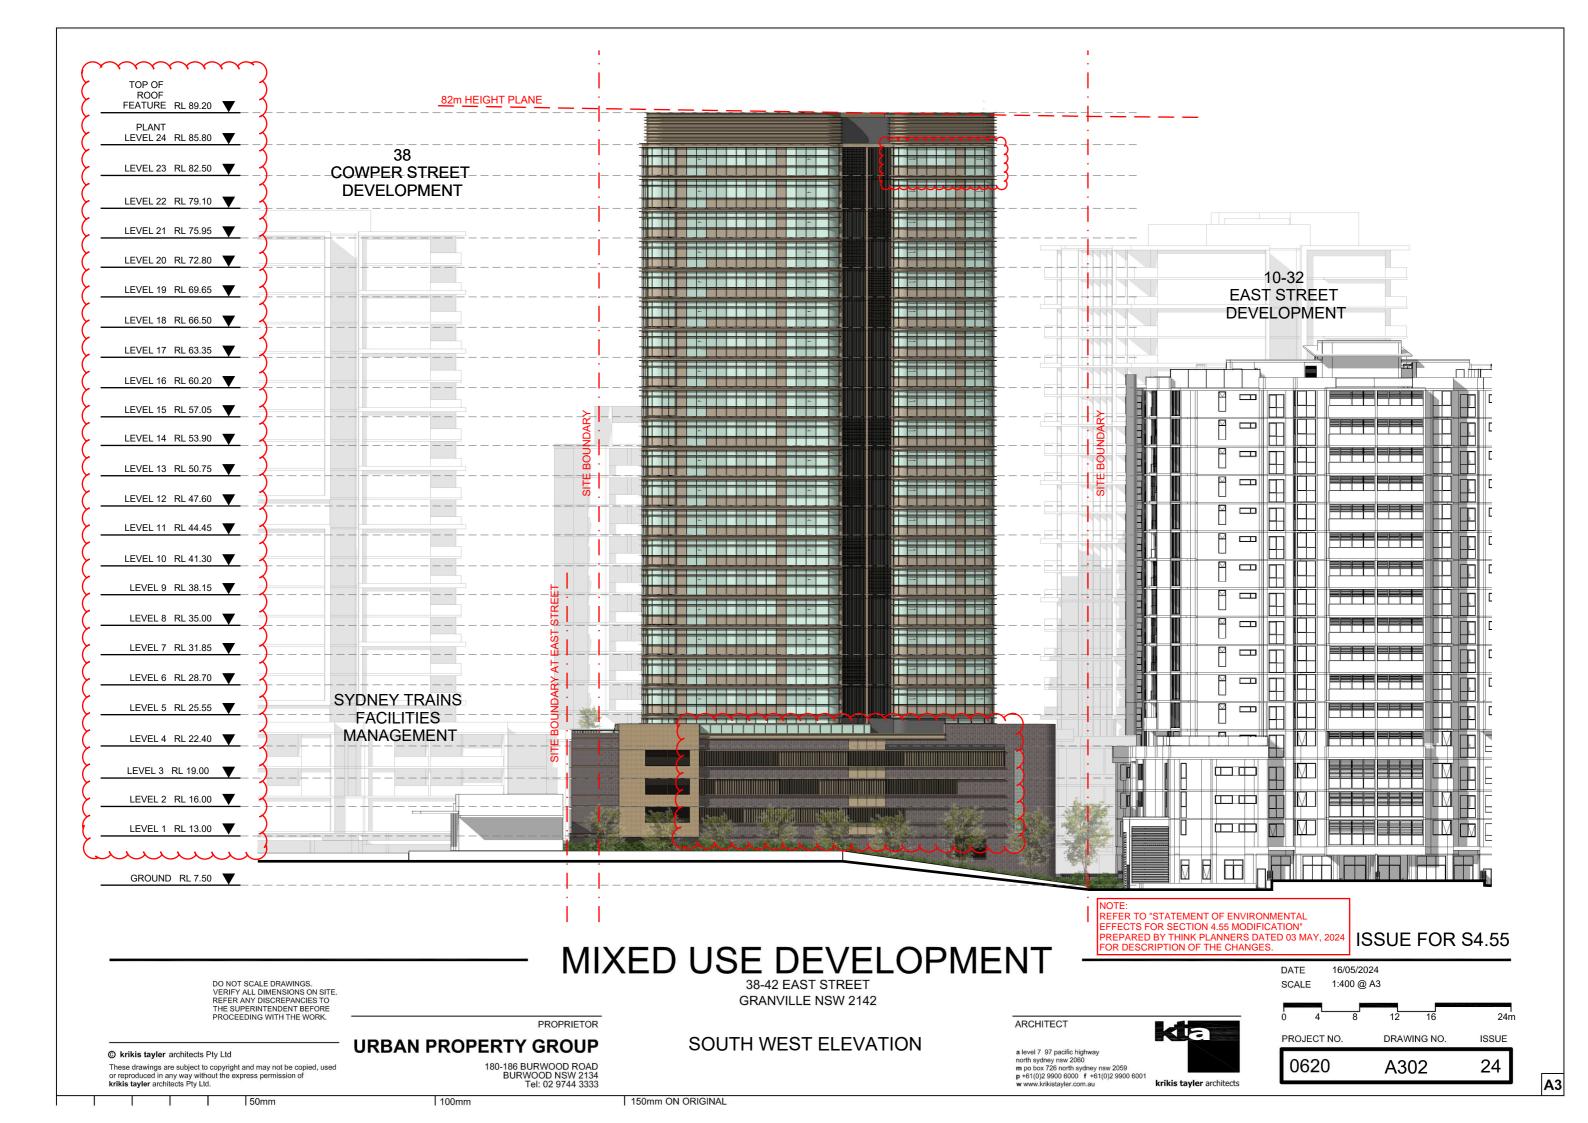


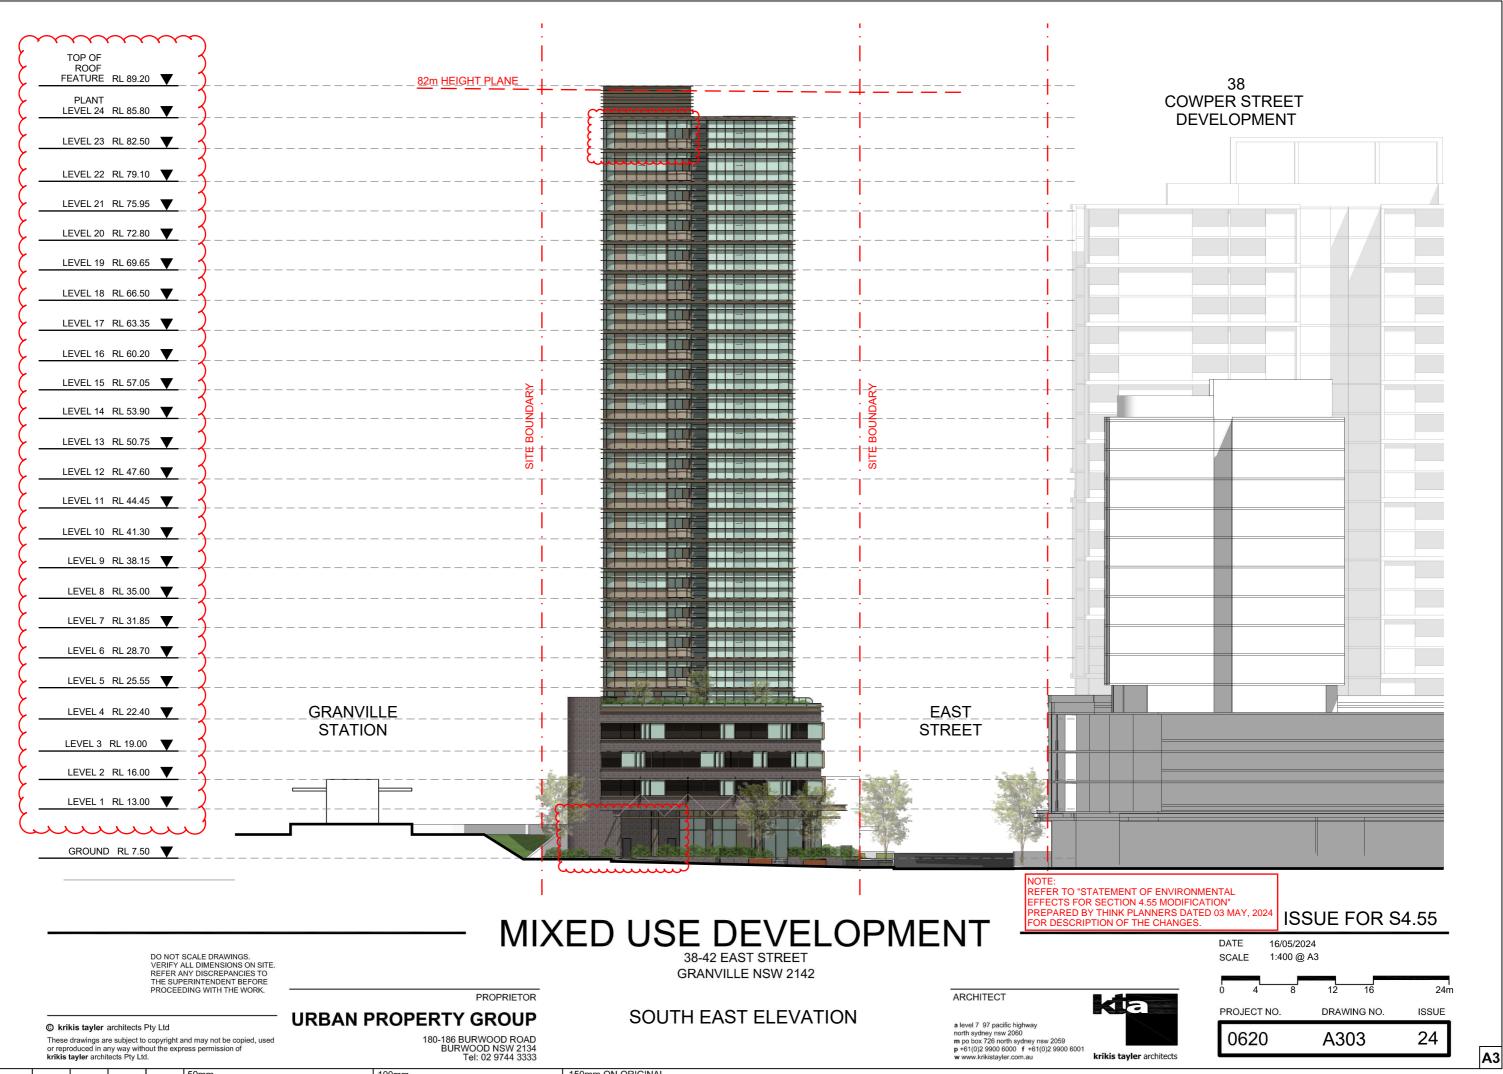

50mm

100mm

150mm ON ORIGINAL

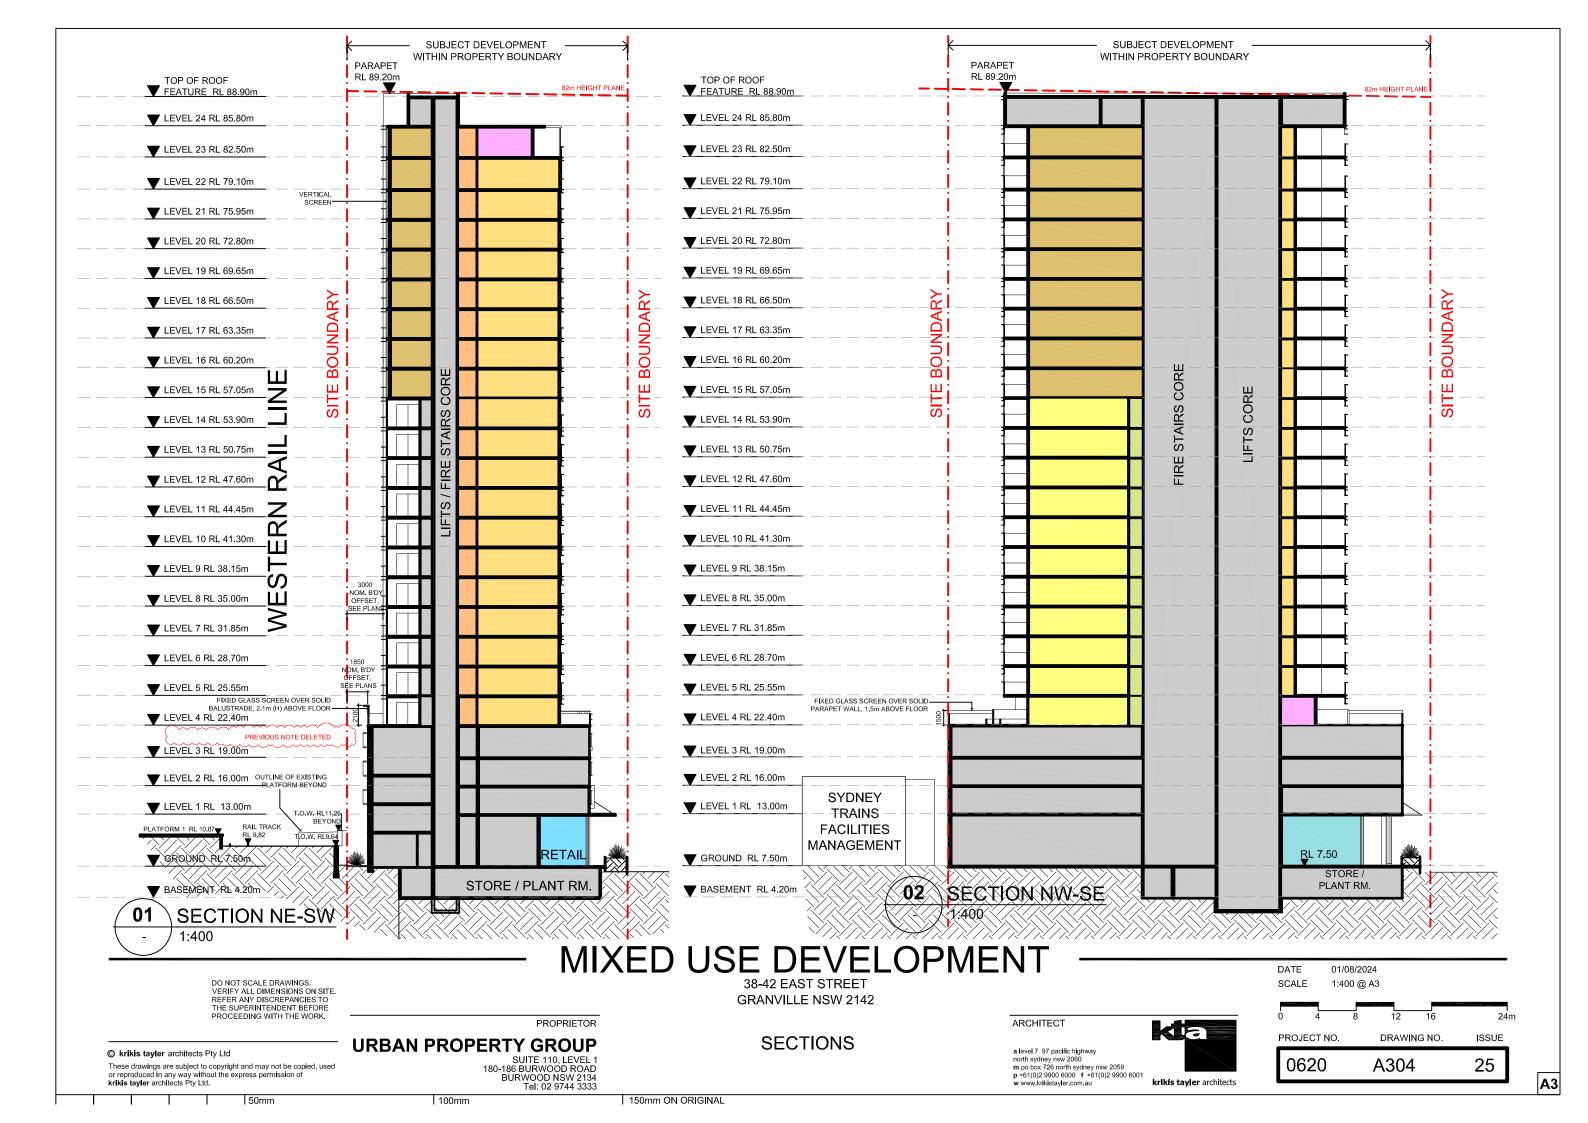

34-42 East Street Granville Landscape S4.55 Modification

Prepared for UPG August 2024



Acknowledgment to Country

We recognise the First Nations People of Australia and celebrate their continuing cultural practice and connection to Country.

We acknowledge the Traditional Custodians of the land on which we live and work, and pay our respect to Elders of the past, present and emerging.

We are proud that we live in the country with the world's oldest continuous living cultures, and we are working on playing our part as allies to First Nations people across Australia.

Always was, always will be.

Issue C: Landscape S4.55 Modification


Date: 6th August 2024 Prepared By: Nicole Wilson, Principal Julia Shreeve, Landscape Architect Ruby Crane, Landscape Architect

Arcadia Sydney Jones Bay Wharf, Lower Deck, Suite 70 26-32 Pirrama Road, Pyrmont NSW 2009 P 02 8571 2900 E sydney@arcadiala.com.au W arcadiala.com.au Arcadia Landscape Architecture Pty Ltd ABN 83 148 994 870


Front Cover: Kippax House Image Credit: Arcadia Landscape Architecture



Landscape Vision

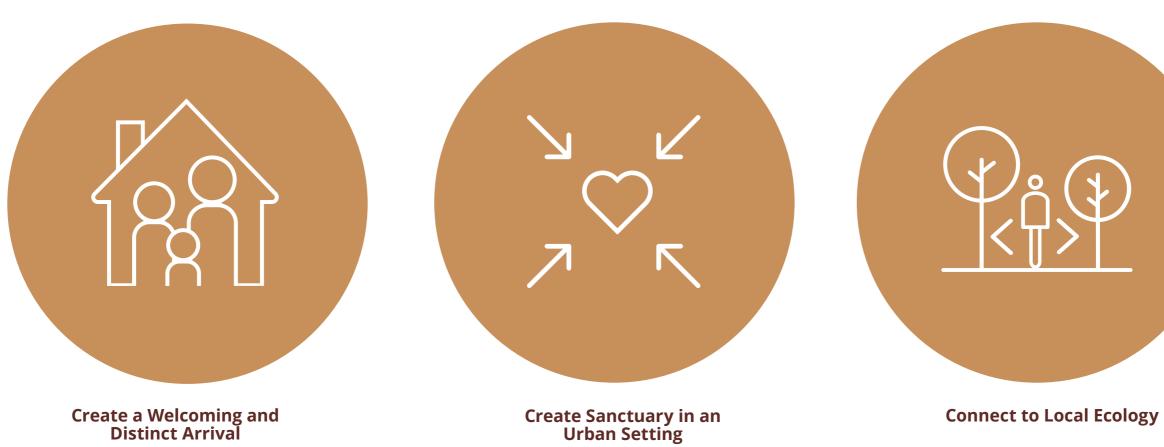



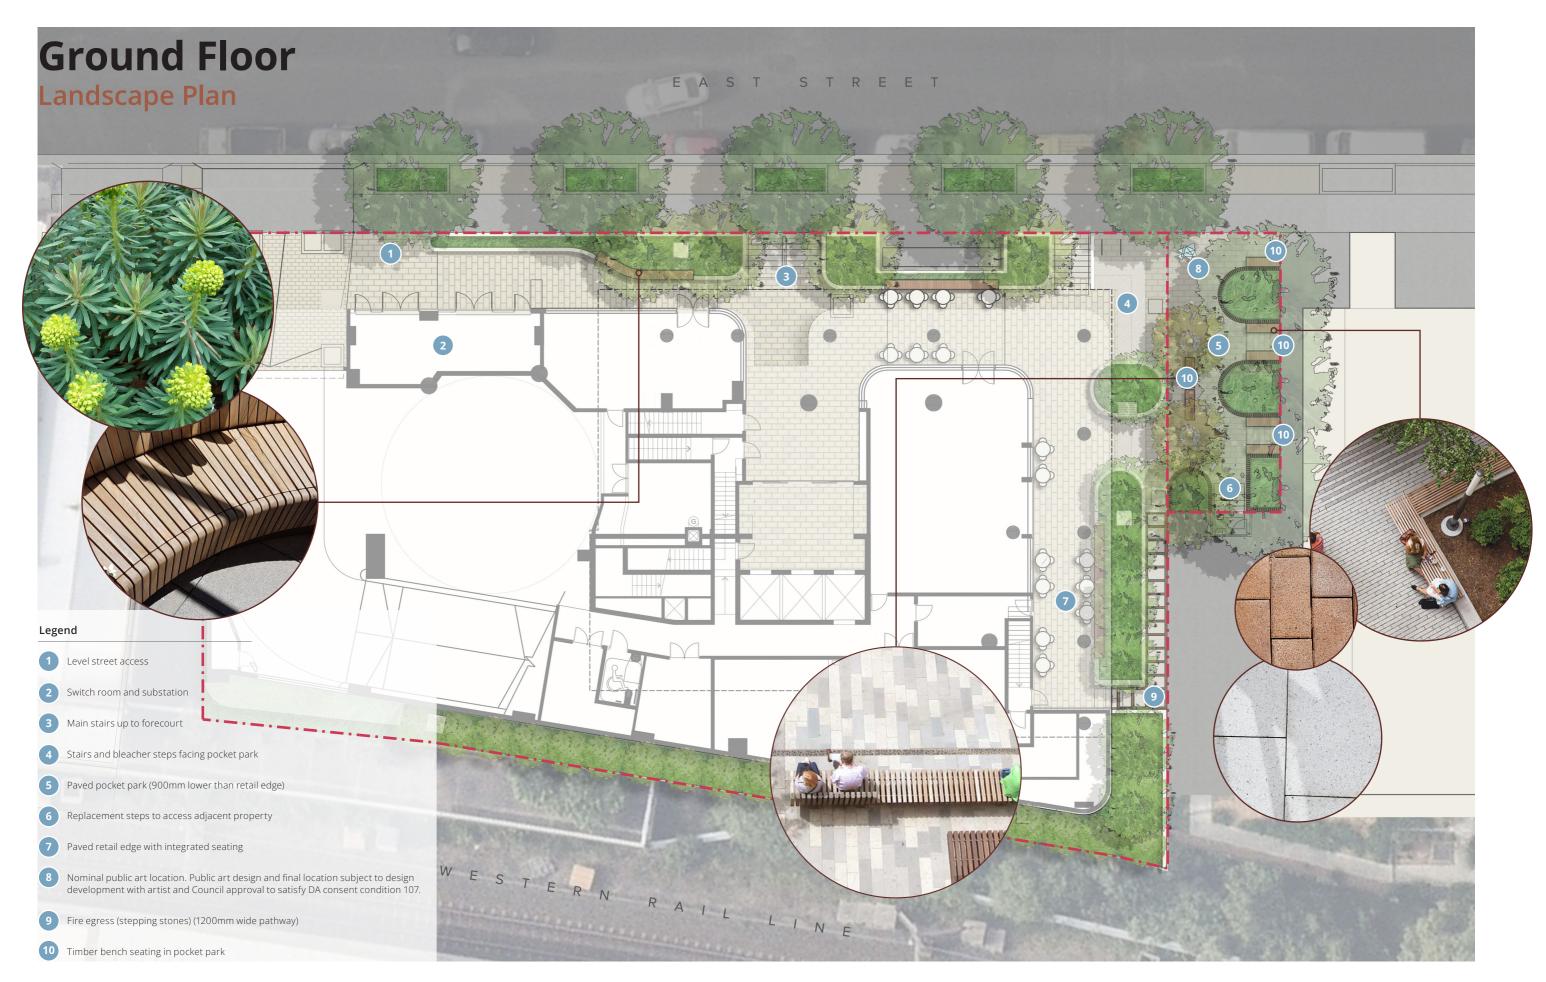

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1:200 @ A3

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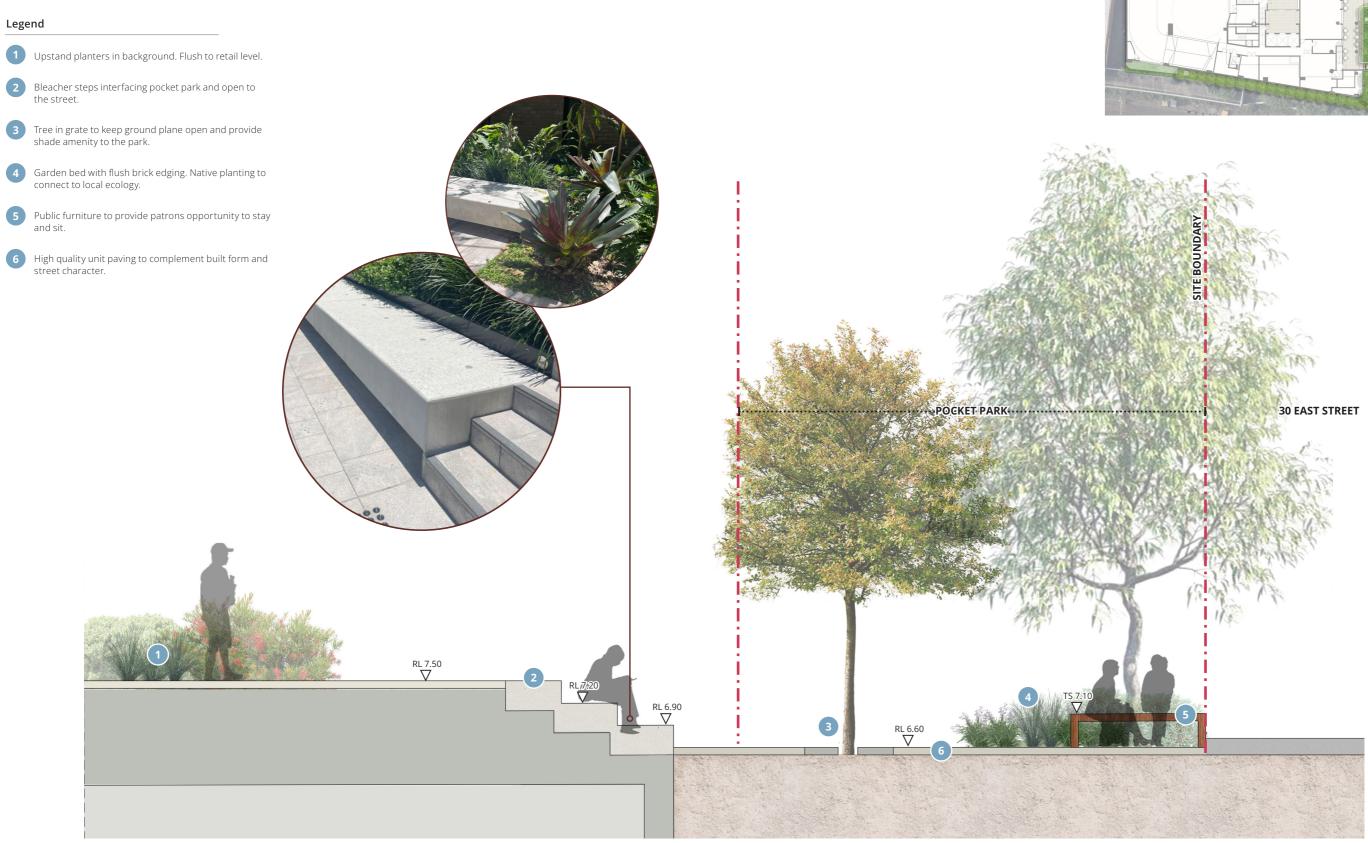
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8m

Ground Floor

Landscape Section



Key Plan



ARCADIA

2m I

1:50 @ A3

0.5



6

@ A3 0 1 2 4 6



Level 4 Communal Space

Landscape Section

Legend

1 Bar top seating integrated into balcony edge planter.

2 Low feature seating centered around raised planter and cabbage tree palm.

3 Lush, low level planting to allow for clear sightlines.

4 Trees to provide canopy and shade amenity.





Key Plan




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2m








Soil Depth

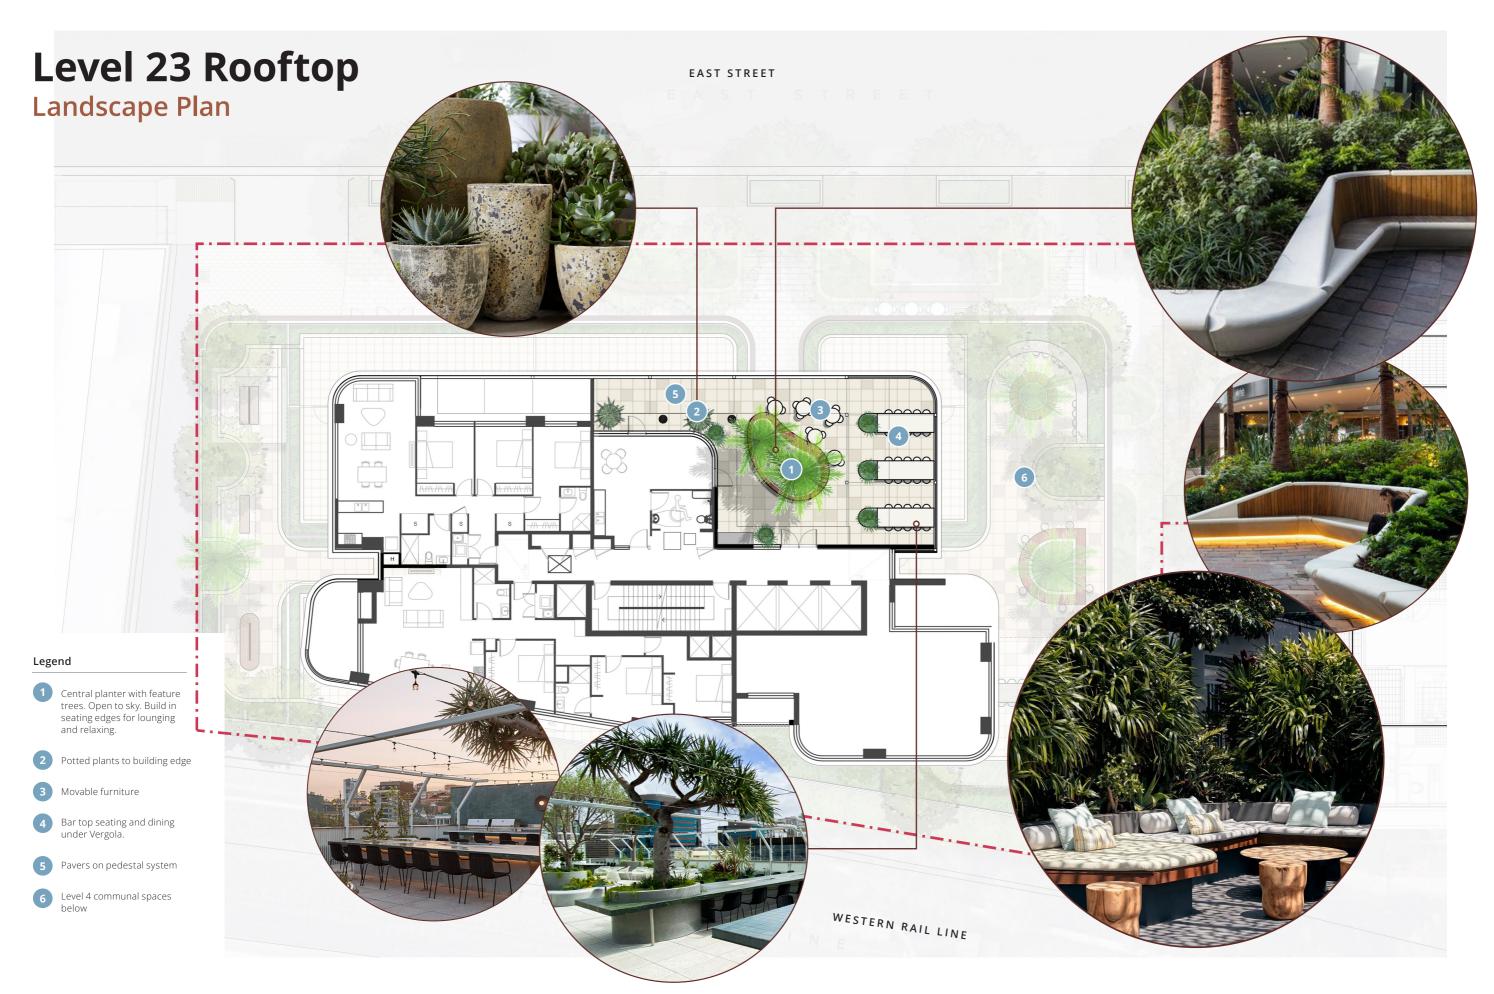Ground Floor

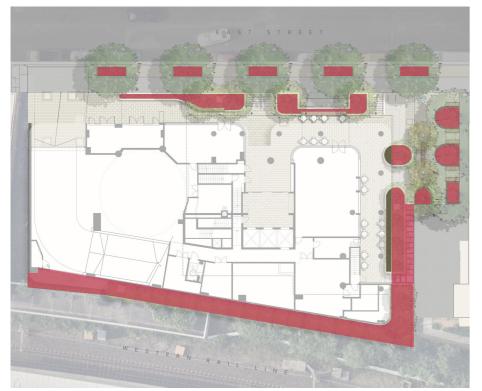

Legend



1000mm Soil Depth Total Area = 9.0 m² Total Volume = 9.0 m³



Deep Soil Zone Total Area = 203.0 m²



Level 4


Legend

600mm Soil Depth Total Area = 15.0 m²

Total Volume = 9.0 m³

1000mm Soil Depth Total Area = 84.0 m² Total Volume = 84.0 m³

Soft Landscaping Total Area = 99.0 m²

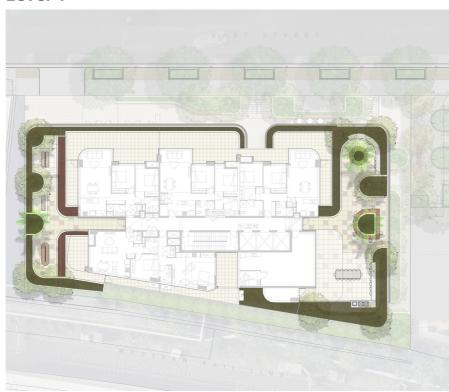



Legend

600mm Soil Depth Total Area = 1.5 m² Total Volume = 0.9 m³


800mm Soil Depth Total Area = 1.0 m² Total Volume = 0.8 m³


1000mm Soil Depth Total Area = 7.0 m² Total Volume = 7.0 m³

Soft Landscaping Total Area = 9.5 m²



Materials Palette

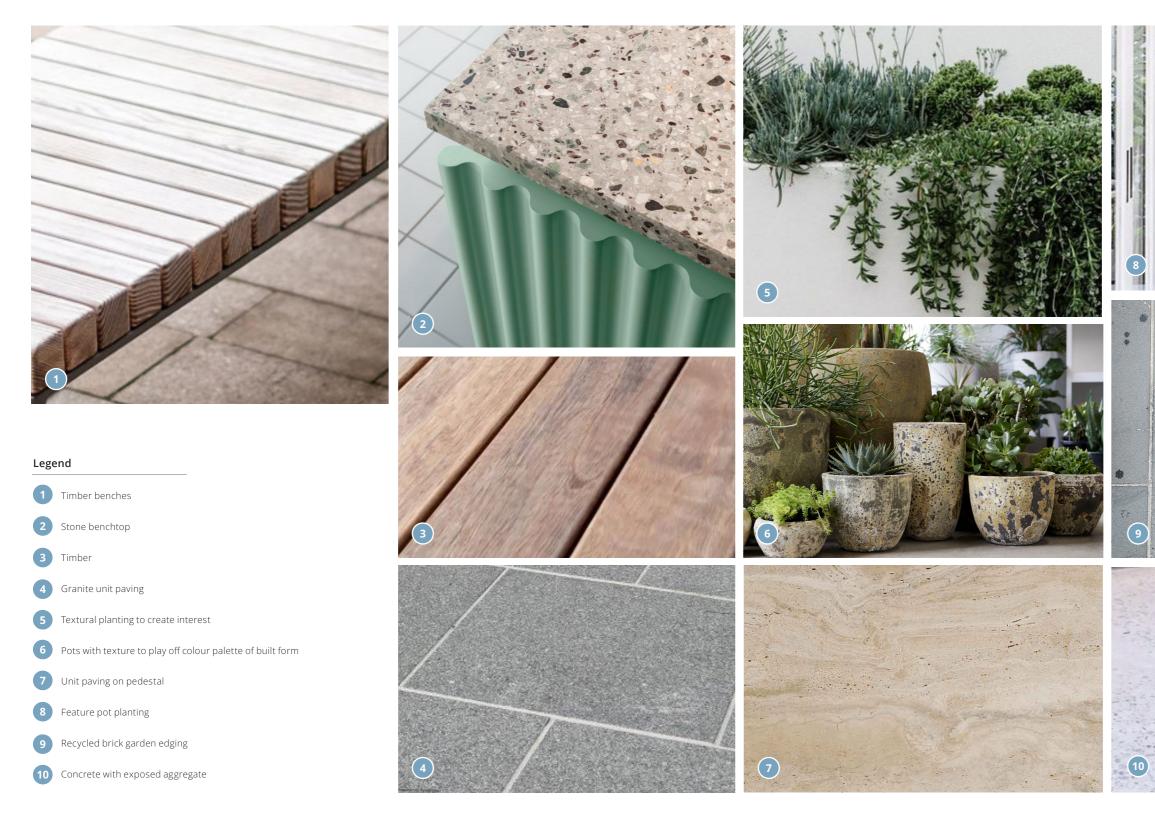

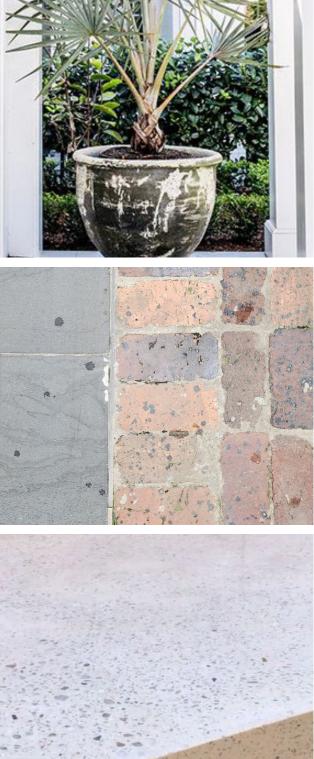



Planting Palette







COVER SHEET

34-42 EAST STREET GRANVILLE, NSW

DRAWING SCHEDULE

DRAWING NO.	DRAWING TITLE
DRAWING NO.	

L-000	COVER SHEET
L-400 L-401 L-402 L-403	PLANTING SCHEDULE SOFTWORKS PLAN - GROUND FLOOR SOFTWORKS PLAN - LEVEL 4 SOFTWORKS PLAN - LEVEL 23

L-600 LANDSCAPE DETAILS

L-700 LANDSCAPE SPECIFICATION NOTES



KEY PLAN

NTS



34-42 EAST STREET GRANVILLE LANDSCAPE S4.55 MODIFICATION



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PREPARED BY Arcadia Landscape Architecture CLIENTUrban Property GroupARCHITECTKrikis Tayler

SCALE **ISSUE** B

DATE 23.04.2024

PLANTING SCHEDULE

EAST STREET GRANVILLE - PLANT SCHEDILLE

CODE	BOTANIC NAME	COMMON NAME	MATURE SIZE (h x w)(m)	PROPOSED POT SIZE	QUANTITY
	TREES & PALMS				
Aps	Acer plamatum 'Senkaki'	Coral Barked Maple	6 x 5	200L	4
Sa	Sapium sebiferum	Chinese Tallow	8 x 8	200L	8
La	Livistona australis	Cabbage Palm	8 x 5	EX Ground (4m Trunk)	5
Lc	Lophostemon confertus	Brush Box	12 x 6	200L	5
Can	Cupaniopsis anacardioides	Tuckeroo	8 x 7	200L	3
ΤI	Tristaniopsis laurina	Water Gum	5 x 3	200L	10
HRUBS	& ACCENTS				
Acl	Acacia cognata 'Limelight'	River Wattle	1 x 1	200mm	13
Ae	Aspidistra elatior	Cast Iron Plant	1.0 x 1.0	200mm	9
Ag	Agave geminiflora	Twin Flowered Agave	1 x 1	200mm	18
Am	Alocasia macrorrhiza	Giant Elephant's Ears	2.0 x 1.0	500mm	3
Ayg	Anigozanthos Yellow Gem	Kangaroo Paw	1.5 x 1	200mm	109
Ca	Correa alba 'Saint Andrews'	White Correa	0.6 x 1	200mm	66
Car	Crassula arborescens	Silver Dolalr	0.8 x 0.8	200mm	48
CLj	Callistemon 'Little John'	Little John Bottlebrush	1 x 1	200mm	17
Cm	Crassula undulatifolia 'Max Cook"	Max Cook	1 x 1	200mm	10
Со	Calathea orbifolia	Round Leaf Prayer Plant	1.0 x 1.0	200mm	5
Ew	Euphorbia "Wulfenii"	Euphorbia	1 x 1	200mm	35
Нр	Helichrysum petiolare	Licorice Plant	1 x 1	200mm	70
Od	Ozothamnus diosmifolius	Rice Flower	1.5 x 1	200mm	10
Рx	Philodendron Xanadu	Drawf Philodendron	1 x 1	200mm	50
Rrf	Russelia Ruby Falls	Firecracker Plant	1 x 1.5	200mm	15
Sn	Strelitzia nicolai	Giant Bird of Paradise	2.5 x 1.0	200mm	2
ERNS					
Ac	Arthropodium cirratum	New Zealand Rock Lily	0.9 x 1	200mm	38
Ссо	Cyathea cooperi	Australian Tree Fern	8 x 3	45L	28
Lm	Liriope muscari	Lily Turf	0.4 x 0.4	200mm	48
ROUND	COVERS, GRASSES & CLIMBERS				
Lp	Libertia paniculata	Branching Flag Grass	0.4 x 0.5	200mm	45
Cg	Casuarina gluaca 'Cousin It"	Cousin It	0.2 x 0.8	200mm	85
Dr	Dichondra repens	Kidney Weed	0.15 x 1	200mm	17
Dre	Dianella revoluta	Flax Lily	0.4 × 0.4	200mm	120
Dsf	Dichondra 'Silver Falls'	Kidney Weed	0.2 x 0.2	200mm	18
Lm	Liriope muscari	Lily Turf	0.4 × 0.4	200mm	143
ΡI	Poa labillardieri	Tussock Grass	0.6 x 0.6	200mm	85
Rb	Rhipsalis baccifera	Mistletoe Cactus	0.2 x 1.0	200mm	21
Ss	Senecio sepens	Blue Chalk Sticks	0.3 x 0.6	200mm	20
Tt	Trachelospermum jasminiodes "Tricolour"	Variegated Star Jasmine	0.5 x 2	200mm	75
Vh	Viola hederacea	Native Violet	0.15 x 1.5	200mm	12
Wlh	Westringia Low Horizon	Low Horizon	0.3 x 0.7	200mm	71
	SHADE MIX				
Dre	Dianella revoluta	Mauve Flax Lily	0.4 x 0.4	150mm	314
Vh	Viola hederacea	Native Violet	0.15 x 1.5	150mm	314
	HERB MIX				
Sr	Salvia rosmarinus	Rosemary	0.3 x 0.8	150mm	6
So	Salvia officinalis cv.	Common Sage	0.6 × 0.6	150mm	6



34-42 EAST STREET GRANVILLE LANDSCAPE S4.55 MODIFICATION

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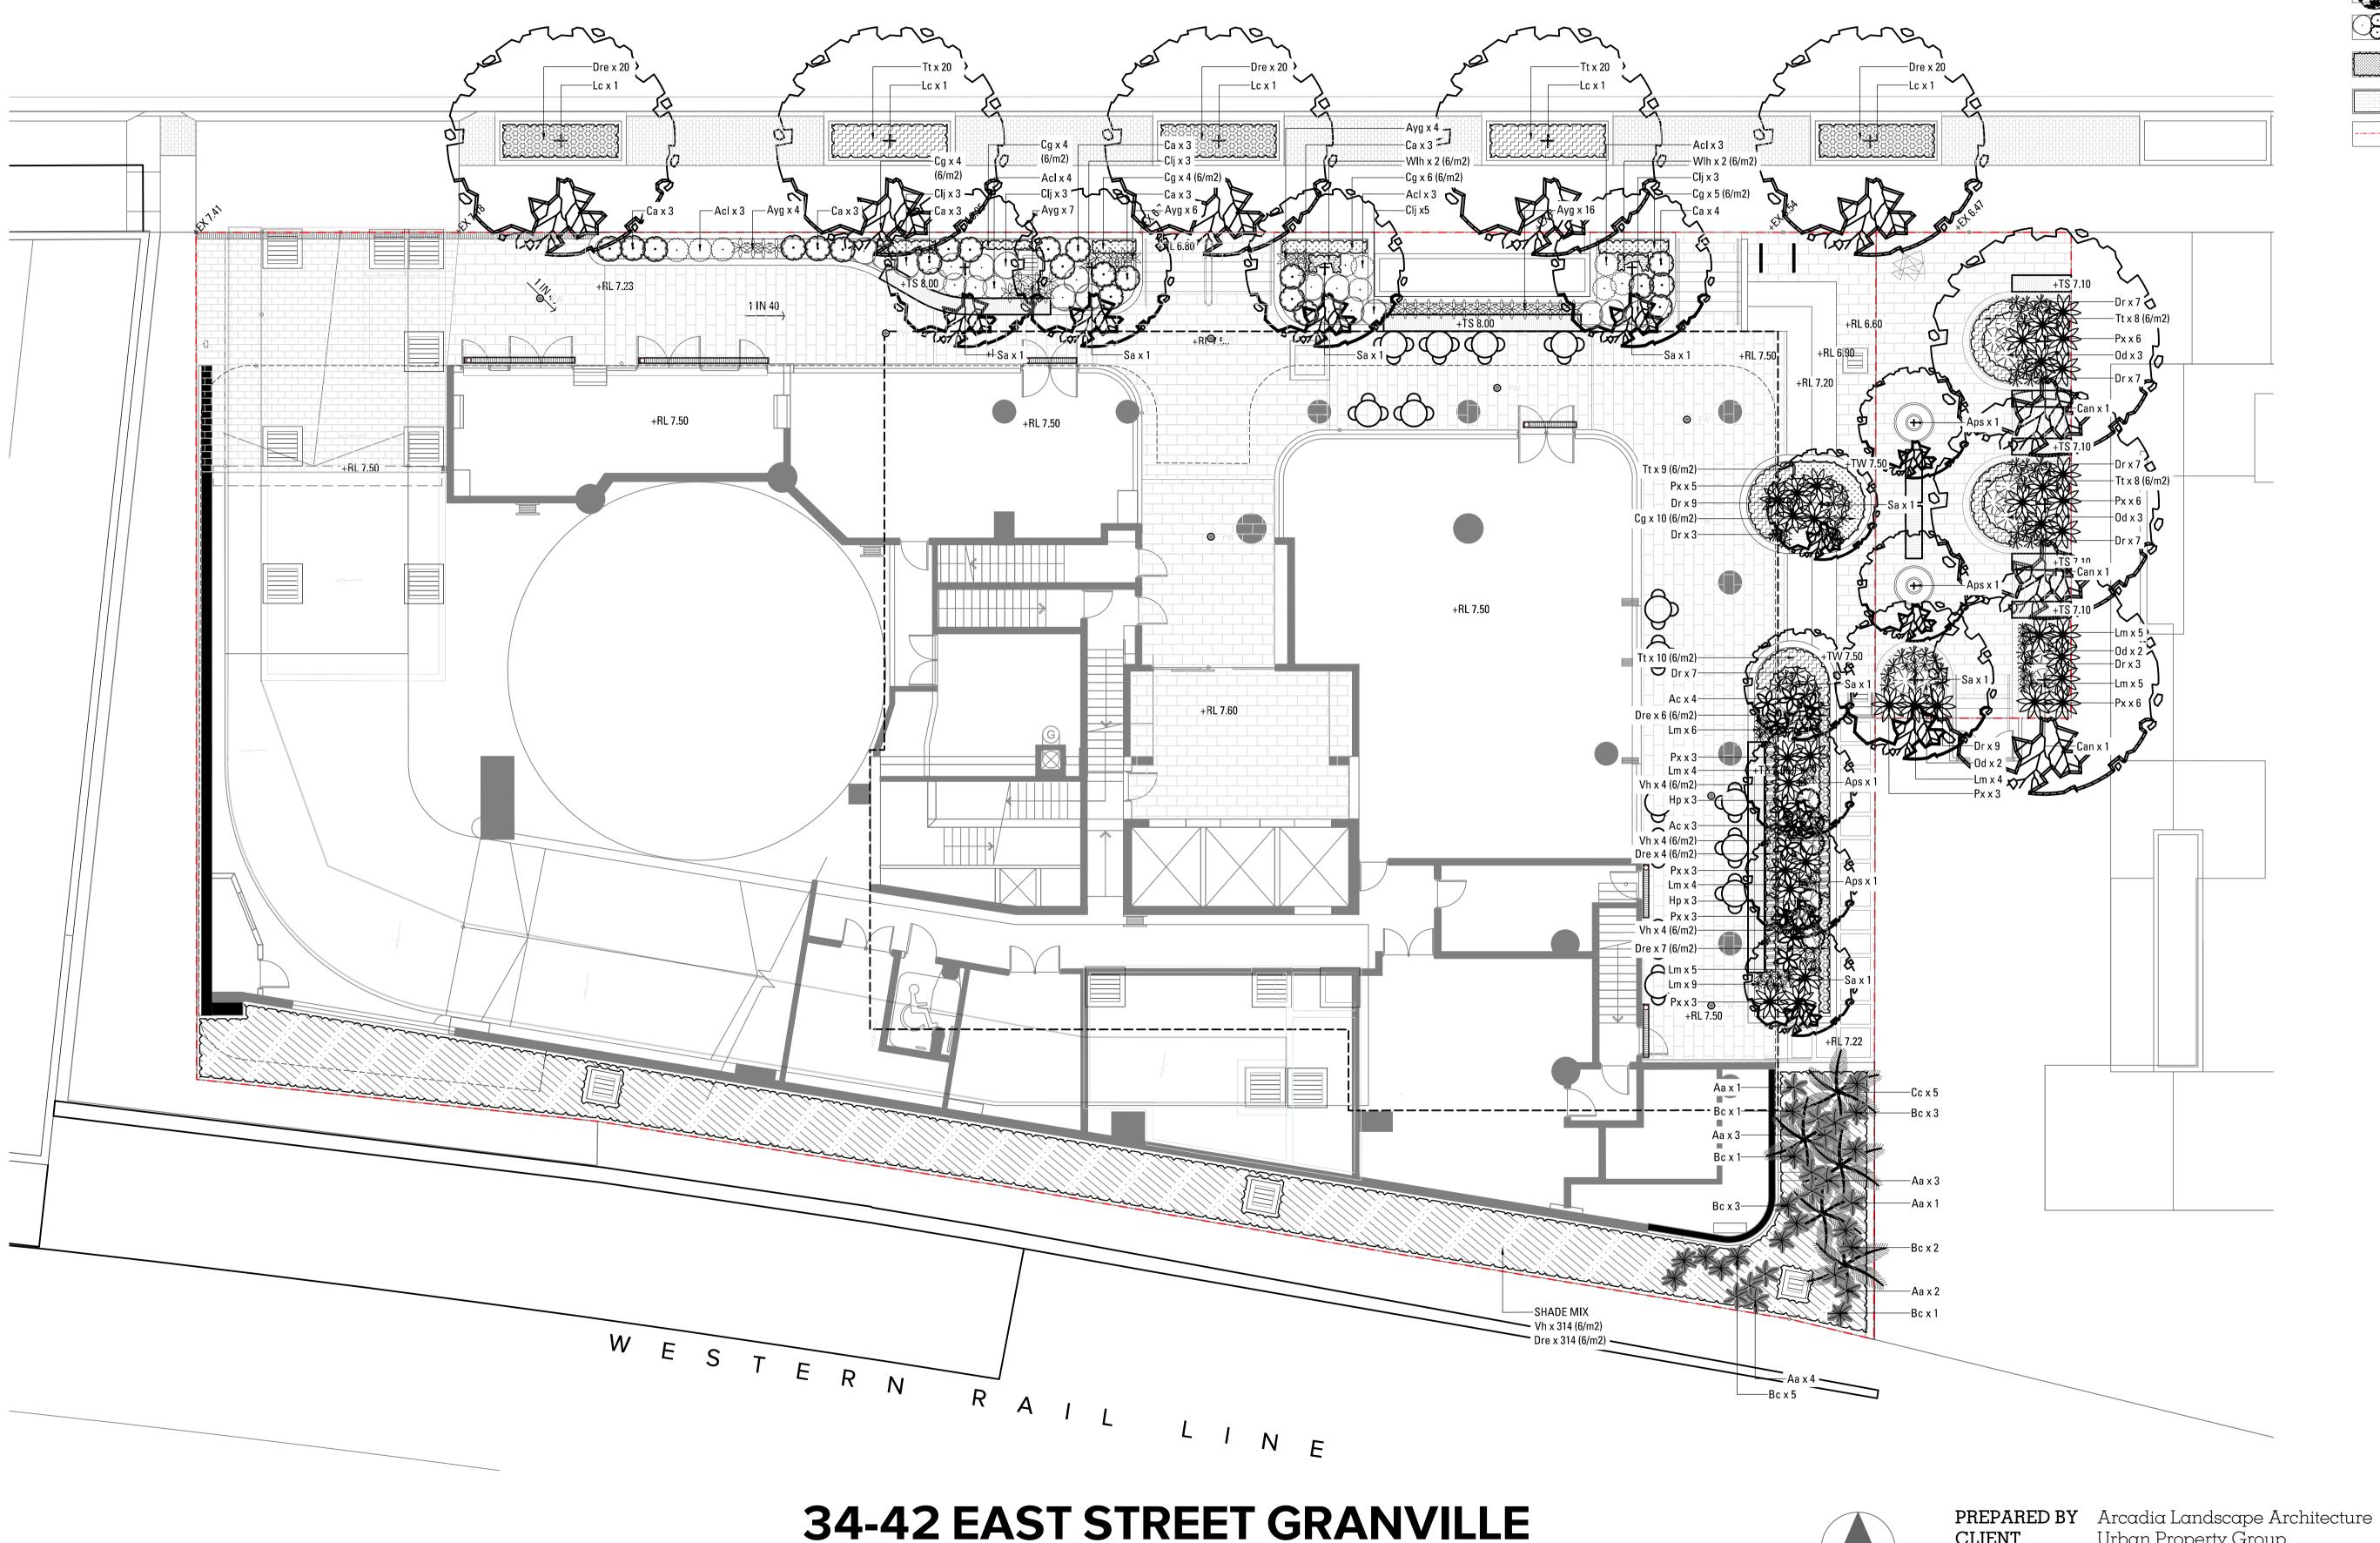


PREPARED BYArcadia Landscape ArchitectureCLIENTUrban Property GroupARCHITECTKrikis Tayler

SCALE ISSUE B

DATE 23.04.2024

SOFTWORKS - GROUND FLOOR



E A S T S T R E E T

LANDSCAPE S4.55 MODIFICATION



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PROPOSED FEATURE TREE PLANTING

PROPOSED SHRUB AND ACCENT PLANTING

PROPOSED UNIT PAVING

SITE BOUNDARY

PROPOSED GROUNDCOVER PLANTING

LEGEND

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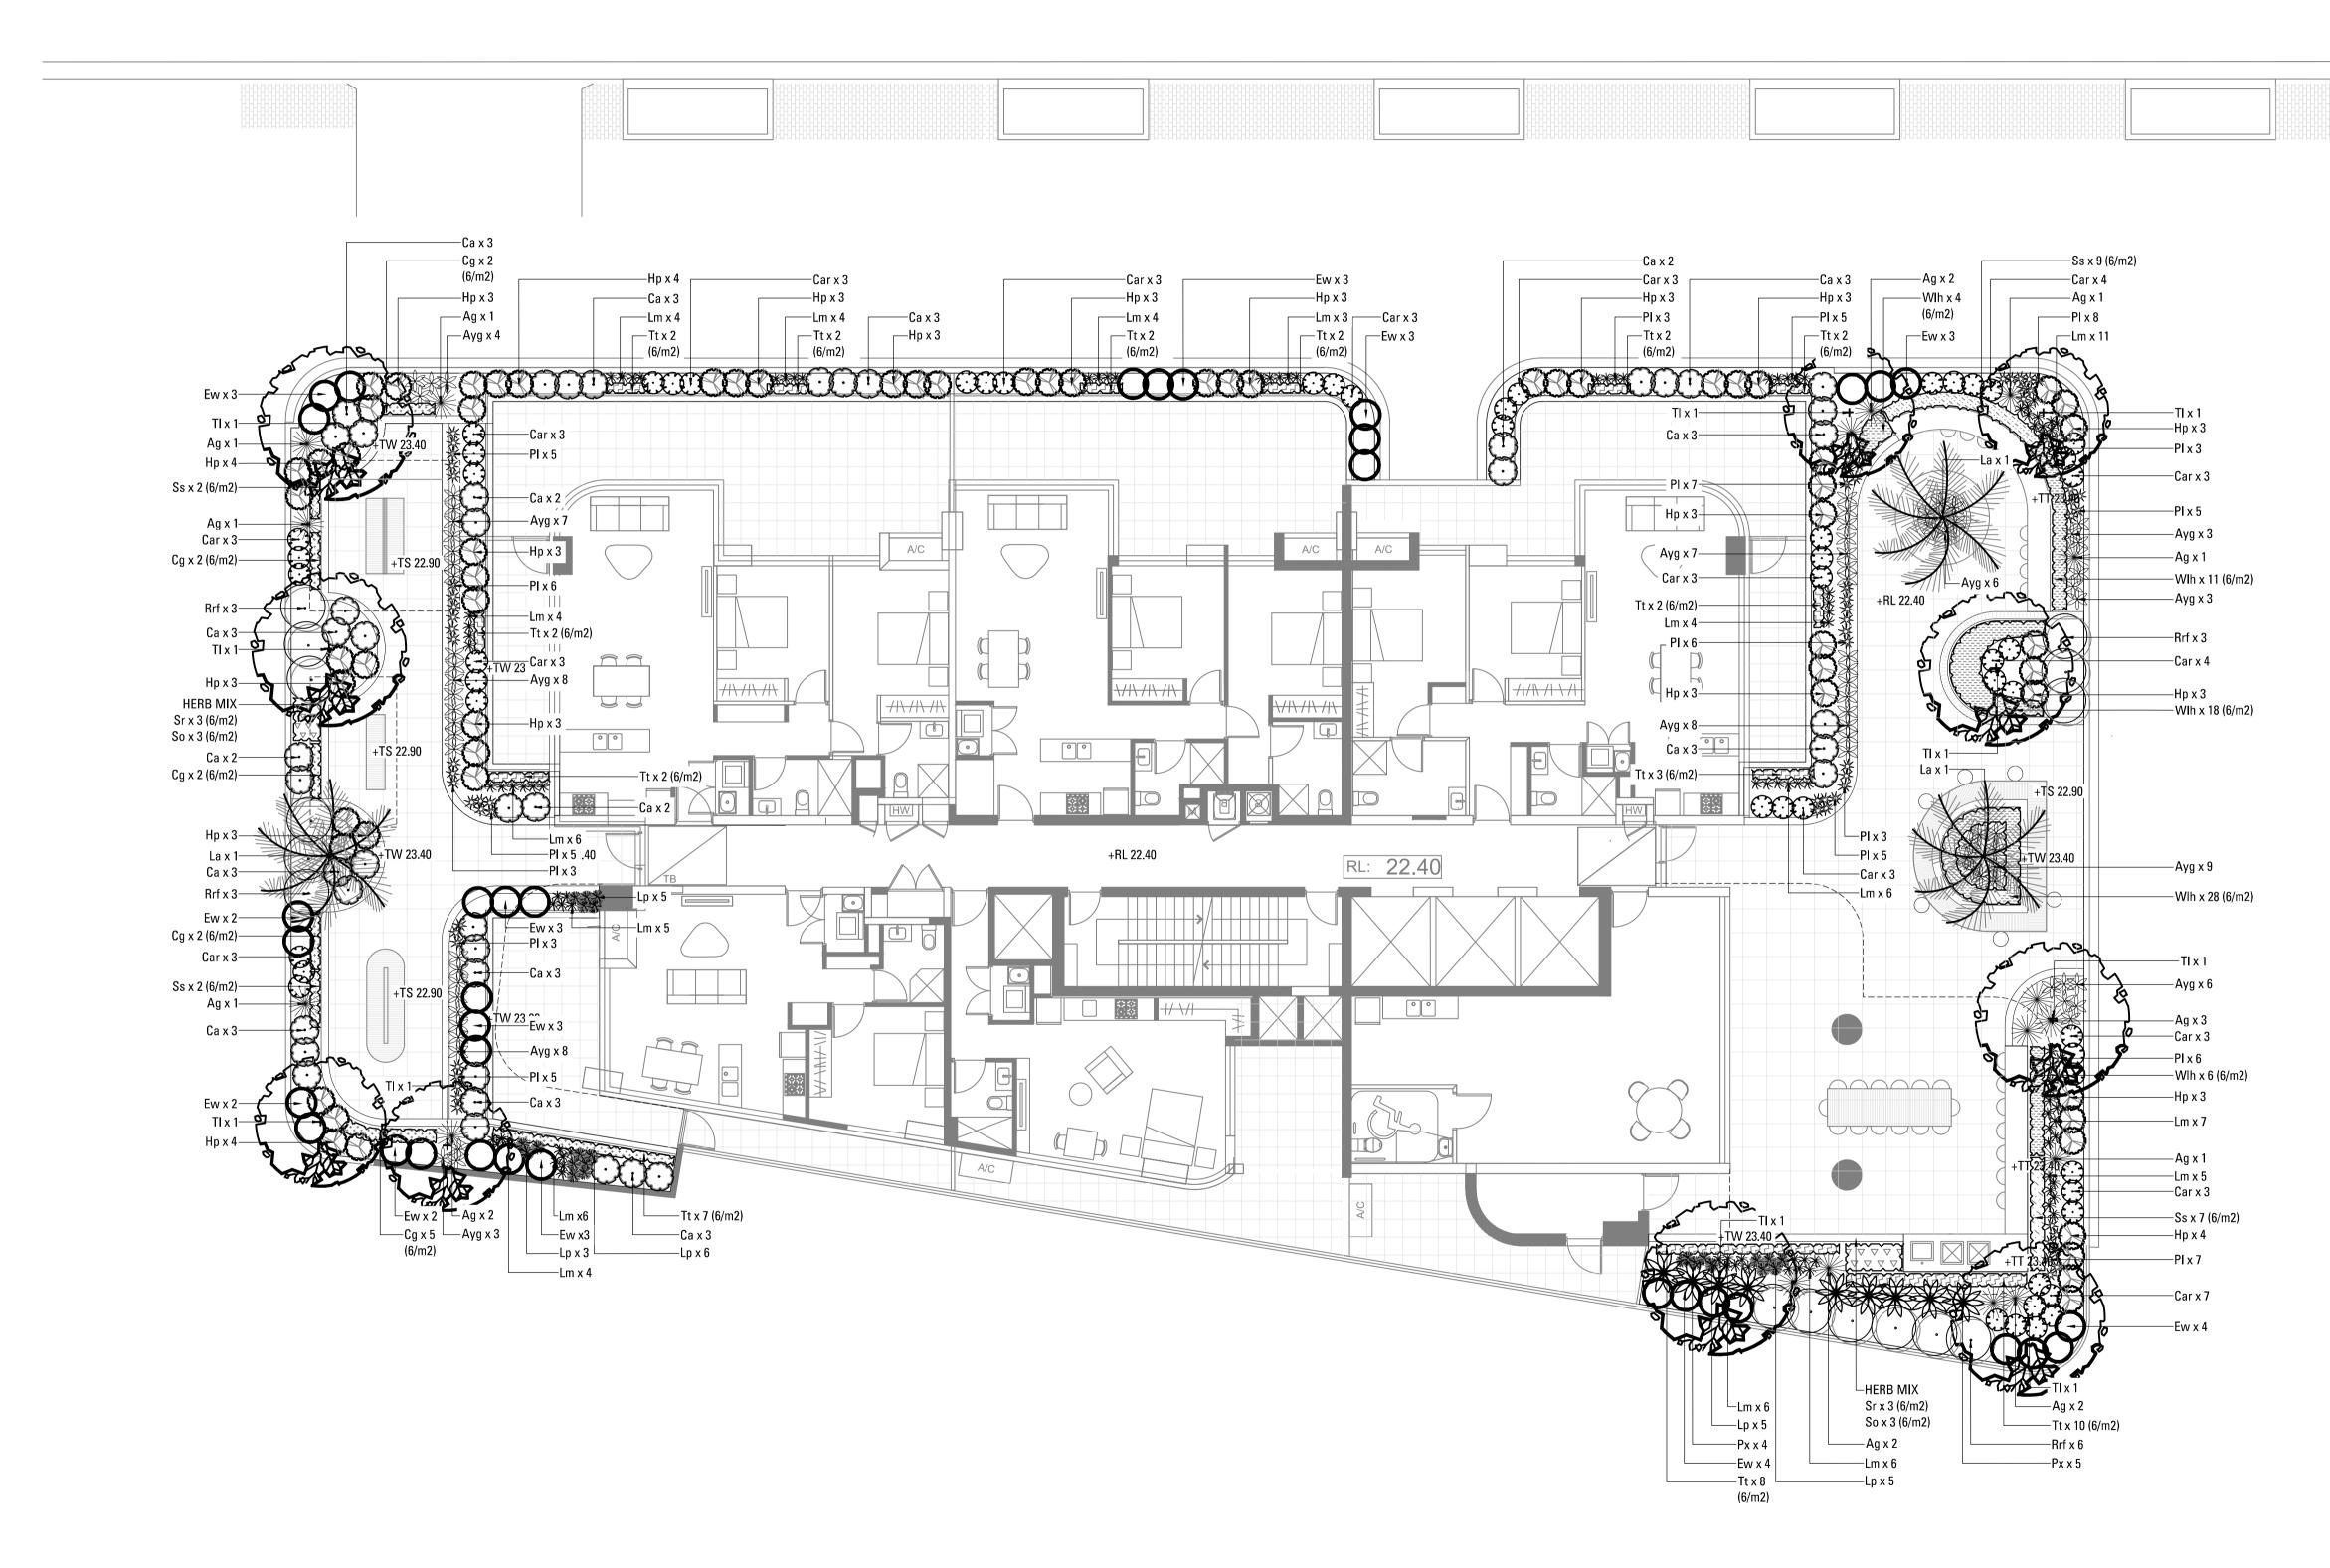
CLIENTUrban Property GroupARCHITECTKrikis Tayler



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SOFTWORKS - LEVEL 4



LANDSCAPE S4.55 MODIFICATION

34-42 EAST STREET GRANVILLE



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CLIENT



PROPOSED FEATURE TREE PLANTING

PROPOSED UNIT PAVING

SITE BOUNDARY

 $\left\{ \cdot \right\}$ PROPOSED SHRUB AND ACCENT PLANTING PROPOSED GROUNDCOVER PLANTING

ARCHITECT


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SOFTWORKS - LEVEL 23





34-42 EAST STREET GRANVILLE



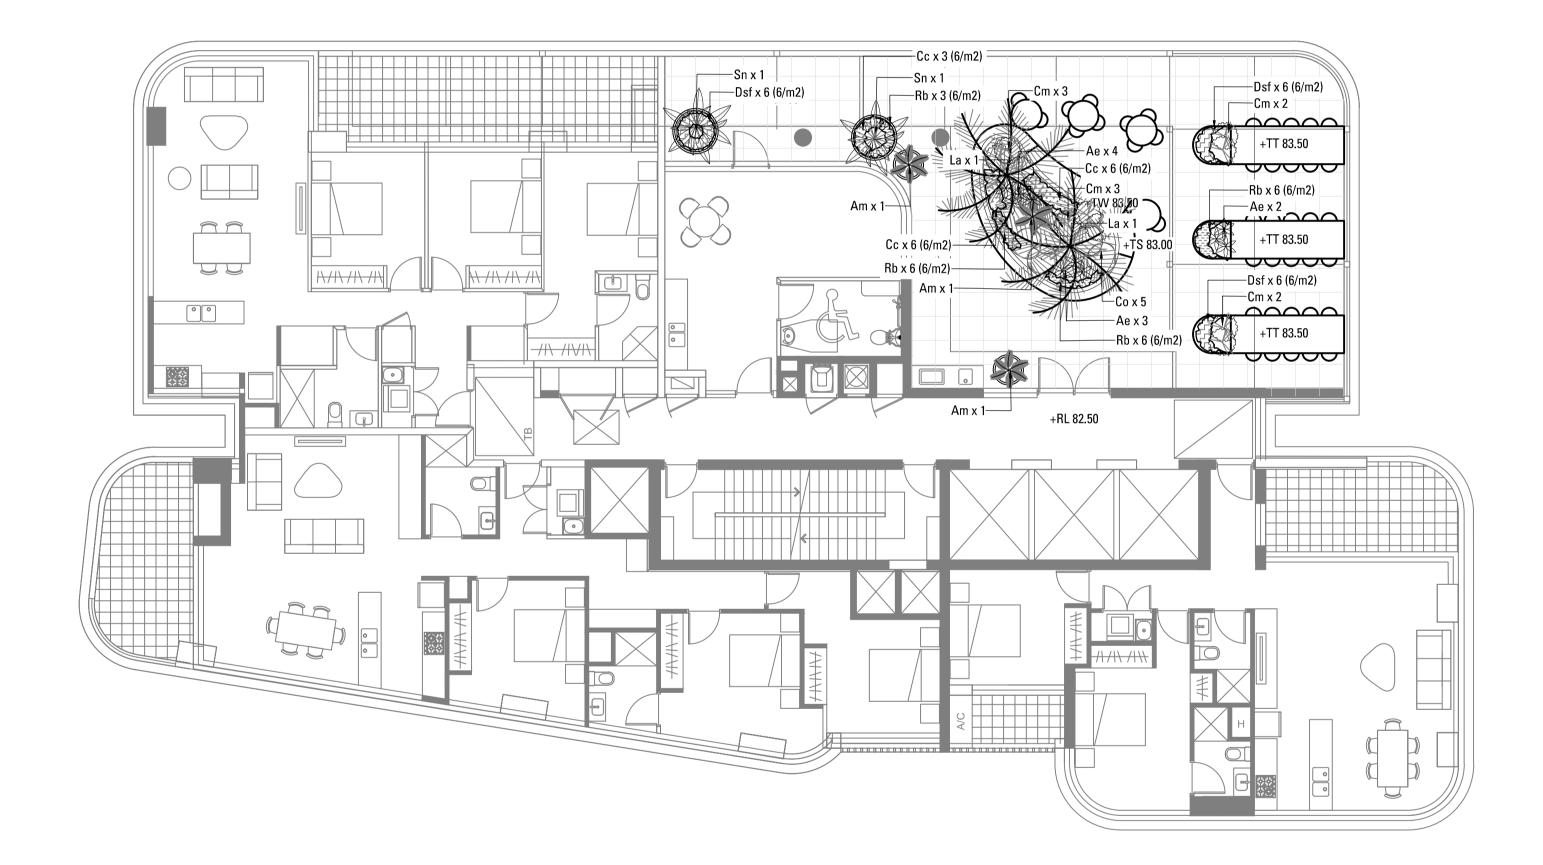

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LEGEND

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PROPOSED SHRUB AND ACCENT PLANTING

PROPOSED FEATURE TREE PLANTING

PROPOSED GROUNDCOVER PLANTING

PROPOSED UNIT PAVING

SITE BOUNDARY


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23.04.2024

LANDSCAPE TYPICAL DETAILS






- PROPOSED SHRUB OR GROUNDCOVER **Refer Specification**

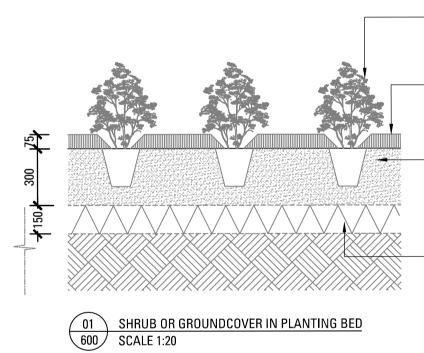- 75mm DEPTH MULCH REFER SPECIFICATION DISHED AROUND BASE OF

TRUNK – BACKFILL & CONSOLIDATE WITH TOPSOIL MIXTURE & FERTILISE TO MIN. 300mm

Refer Specification

- BREAKUP & CULTIVATE SUBGRADE TO 150mm DEPTH

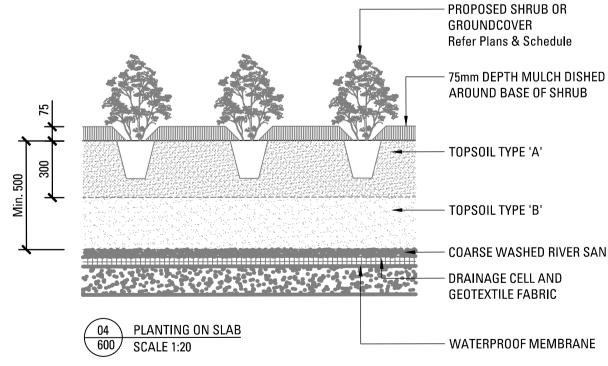

— TOPSOIL TYPE 'A'


AROUND BASE OF SHRUB


TOPSOIL TYPE 'B'

- COARSE WASHED RIVER SAND DRAINAGE CELL AND GEOTEXTILE FABRIC

WATERPROOF MEMBRANE



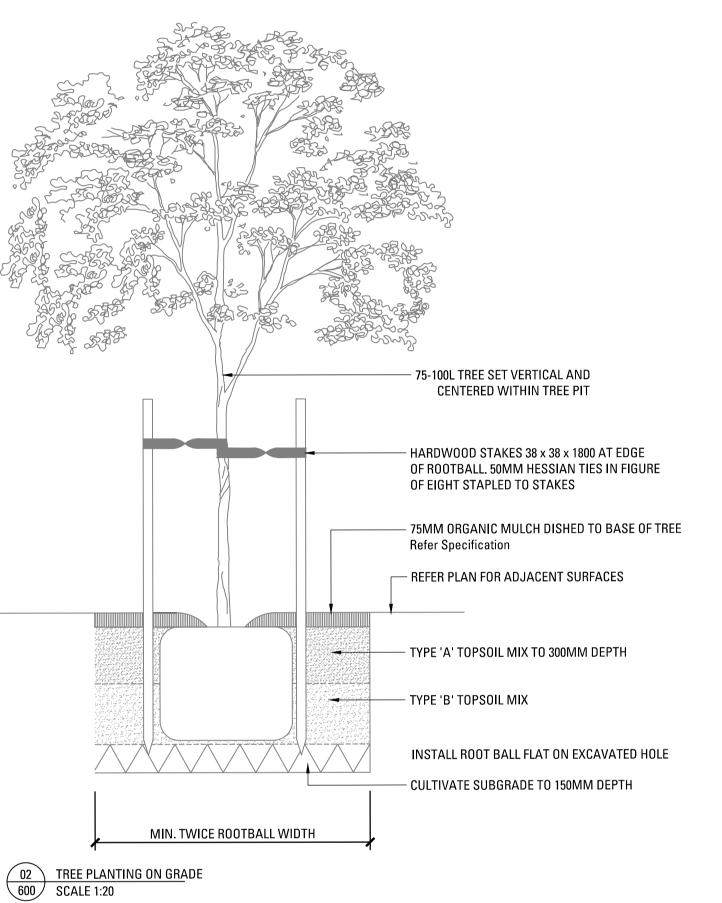

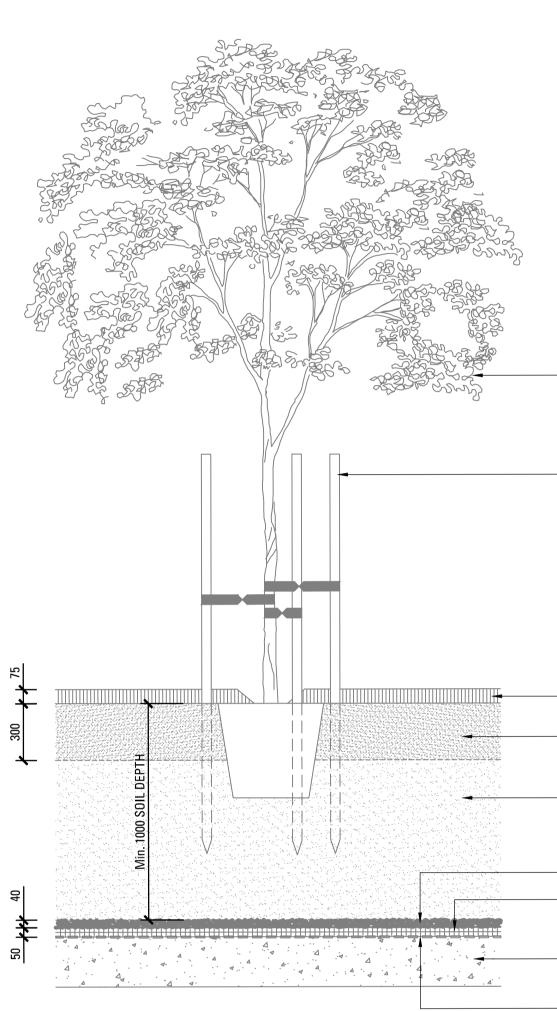



03 TREE PLANTING ON SLAB 600 SCALE 1:20

34-42 EAST STREET GRANVILLE





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ADVANCED TREE As Specified

- STAKES AND TIES

- 75mm DEPTH MULCH

- TOPSOIL TYPE 'A'

- BACKFILL AND CONSOLIDATE WITH LIGHTWEIGHT PLANTER SOIL

- COARSE WASHED RIVER SAND – DRAINAGE CELL AND GEOTEXTILE FABRIC

- SUSPENDED CONCRETE SLAB

- WATERPROOF MEMBRANE

PREPARED BY Arcadia Landscape Architecture CLIENTUrban Property GroupARCHITECTKrikis Tayler



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LANDSCAPE SPECIFICATION NOTES

LANDSCAPE SPECIFICATION NOTES

SERVICES

BEFORE LANDSCAPE WORK IS COMMENCED THE LANDSCAPE CONTRACTOR IS TO ESTABLISH THE POSITION OF ALL SERVICE LINES AND ENSURE TREE PLANTING IS CARRIED OUT AT LEAST 3 METRES AWAY FROM THESE SERVICES. SERVICE LIDS, VENTS AND HYDRANTS SHALL BE LEFT EXPOSED AND NOT COVERED BY ANY LANDSCAPE FINISHES (TURFING, PAVING, GARDEN BEDS ETC.) FINISH ADJOINING SURFACES FLUSH WITH PIT LIDS.

ABORIST MANAGEMENT OF TREE PROTECTION

A QUALIFIED AND APPROVED ABORIST IS TO BE CONTRACTED TO UNDERTAKE OR MANAGE THE INSTALLATION OF PROTECTIVE FENCING, AND TO UNDERTAKE SUCH MEASURES AS HE DEEMS APPROPRIATE TO PRESERVE THE SUBJECT TREES TO BE RETAINED. THE ARBORIST IS TO BE RETAINED FOR THE ENTIRE CONTRACT PERIOD TO UNDERTAKE ONGOING MANAGEMENT AND REVIEW OF THE TREES.

DRAINAGE CELL AND FILTER FABRIC

FOR ON-SLAB AREAS INSTALL AN APPROVED 'DRAINAGE CELL' PRODUCT TO COMPREHENSIVELY COVER THE BOTTOM OF ALL PLANTERS. OVER DRAINAGE CELL TO ON-SLAB AREAS, A POLYFELT GEOTEXTILE LINING (AS SUPPLIED BY 'POLYFELT TS' OR APPROVED EQUIVALENT) IS TO BE INSTALLED TO COVER THE BOTTOM OF ALL PLANTERS, TURNED UP 300MM AND TAPED TO THE PLANTER SIDES TO ENSURE SOIL MIX DOES NOT ESCAPE INTO DRAINAGE OUTLETS/HOLES. INSTALL MIN. 50MM COARSE RIVER SAND OVER ALL GEOTEXTILE LINING PRIOR TO INSTALLATION OF SOIL MIX.

PLANTING MIXTURE

IMPORTED TOPSOIL TYPE 'A' : BENEDICT SMART MIX NUMBER 4 - LIGHTWEIGHT PLANTER BOX MIX. IMPORTED TOPSOIL TYPE 'B' : BENEDICT SMART MIX NUMBER 5 - LIGHTWEIGHT PLANTER BOX MIX.

IMPORTED TOPSOIL TYPE 'C' : BENEDICT SMART MIX NUMBER 6 - NATIVE GARDEN SOIL MIX. OR AN IMPORTED SOIL BLEND SOIL TESTING OF EXISTING SITE SOIL IS TO BE UNDERTAKEN TO ASSESS SUITABILITY OF USE AS PLANTING TOPSOIL AND COMPLIANCE WITH AUSTRALIAN STANDARDS.

MULCH APPLICATION

PLACE MULCH TO THE REQUIRED DEPTH, (REFER TO DRAWINGS) CLEAR OF PLANT STEMS, AND RAKE TO AN EVEN SURFACE FINISHING 25MM BELOW ADJOINING LEVELS. ENSURE MULCH IS WATERED IN AND TAMPED DOWN DURING INSTALLATION.

MULCH TYPE PINE BARK: FROM MATURE TREES, GRADED IN SIZE FROM 15MM TO 30MM, FREE FROM WOOD SLIVERS. DARK BROWN IN COLOUR AND TEXTURE.

COMPOST

SHALL BE WELL ROTTED VEGETATIVE MATERIAL OR ANIMAL MANURE, OR OTHER APPROVED MATERIAL, FREE FROM HARMFUL CHEMICALS, GRASS AND WEED GROWTH AND WITH NEUTRAL PH. PROVIDE A CERTIFICATE OF PROOF OF PH UPON REQUEST.

PLANT MATERIAL

ALL PLANTS SUPPLIED ARE TO CONFORM WITH THOSE SPECIES LISTED IN THE PLANT SCHEDULE ON THE DRAWINGS. GENERALLY PLANTS SHALL BE VIGOROUS, WELL ESTABLISHED, HARDENED OFF, OF GOOD FORM CONSISTENT WITH SPECIES OR VARIETY, NOT SOFT OR FORCED, FREE FROM DISEASE OR INSECT PESTS WITH LARGE HEALTHY ROOT SYSTEMS AND NO EVIDENCE OF HAVING BEEN RESTRICTED OR DAMAGED. TREES SHALL HAVE A LEADING SHOOT. IMMEDIATELY REJECT DRIED OUT, DAMAGED OR UNHEALTHY PLANT MATERIAL BEFORE PLANTING. ALL STOCK IS TO BE CONTAINER GROWN FOR A MINIMUM OF SIX (6) MONTHS PRIOR TO DELIVERY TO SITE

FERTILISER MASS PLANTING AREAS: FERTILISER SHALL BE 'NUTRICOTE' OR APPROVED EQUIVALENT IN GRANULE FORM INTENDED FOR SLOW RELEASE OF PLANT NUTRIENTS OVER A PERIOD OF APPROXIMATELY NINE MONTHS. THOROUGHLY MIX FERTILISER WITH PLANTING MIXTURE AT THE RECOMMENDED RATE, PRIOR TO INSTALLING PLANTS.

TURE

SHALL BE SIR WALTER BUFFALO. SHIRLEYS NO. 17 OR APPROVED EQUAL LAWN FOOD SHALL BE THOROUGHLY MIXED INTO THE TOPSOIL PRIOR TO PLACING TURF.

TREES IN GRASS AND SUPER ADVANCED TREES:

PELLETS SHALL BE IN THE FORM INTENDED TO UNIFORMLY RELEASE PLANT FOOD ELEMENTS FOR A PERIOD OF APPROXIMATELY NINE MONTHS EQUAL TO SHIRLEYS KOKEI PELLETS, ANALYSIS 6.3:1.8:2.9. KOKEI PELLETS SHALL BE PLACED AT THE TIME OF PLANTING TO THE BASE OF THE PLANT, 50MM MINIMUM FROM THE ROOT BALL AT A RATE OF TWO PELLETS PER 300MM OF TOP GROWTH TO A MAXIMUM OF 8 PELLETS PER TREE.

STAKING AND TYING

STAKES SHALL BE STRAIGHT HARDWOOD, FREE FROM KNOTS AND TWISTS, POINTED AT ONE END AND

SIZED ACCORDING TO SIZE OF PLANTS TO BE STAKED

- A. 5-15 LITRE SIZE PLANT 1X(1200X25X25MM)
- 35-75 LITRE SIZE PLANT 2X(1500X38X38MM) 100-GREATER THAN 200LITRE 3X(1800X50X50MN

TIES SHALL BE 50MM WIDE HESSIAN WEBBING OR APPROVED EQUIVALENT NAILED OR STAPLED TO STAKE. DRIVE STAKES A MINIMUM ONE THIRD OF THEIR LENGTH, AVOIDING DAMAGE TO THE ROOT SYSTEM, ON THE WINDWARD SIDE OF THE PLANT.

IBBIGATION SYSTEM

SUPPLY AN AUTOMATIC WATERING SYSTEM USING 'TORO IRRIGATION SYSTEM' OR SIMILAR APPROVED. WITH MICRO-JET SPRINKLER HEADS AND LOW DENSITY, RUBBER MODIFIED POLYPROPYLENE RETICULATION, TO INCLUDE FILTERS, BENDS JUNCTIONS, ENDS AND OTHER ANCILLARY EQUIPMENT. THE LANDSCAPER SHALL NOMINATE HIS SOURCE OF SUPPLY FOR THE WATERING SYSTEM AND OBTAIN APPROVAL FROM THE SUPERINTENDENT BEFORE PLACING ORDERS FOR EQUIPMENT OR SUPPLY.

A SCHEMATIC PLAN OF THE PROPOSED IRRIGATION SYSTEM IS TO BE PREPARED BY THE CONTRACTOR, SHOWING SOLENOIDS, PIPE DIAMETERS, AND ALL NOZZLE AND TRICKLE ATTACHMENT TYPES (INCLUDING SPRAY/HEAD ANGLE), FOR REVIEW BY THE SUPERINTENDENT PRIOR TO INSTALLATION

THE CONTRACTOR IS TO LIASE WITH THE HYDRAULIC ENGINEER AND COUNCIL AS NECESSARY, TO ENSURE THE THE IRRIGATION SYSTEM CONFORMS WITH ALL THE COUNCIL AND WATER BOARD CODES AND REQUIREMENTS.

PROVIDE AN AUTOMATIC CONTROLLER THAT PROVIDES FOR TWO WEEK SCHEDULING AND HOURLY MULTI-CYCLE OPERATION. THE CONTROLLER SHALL MANUAL OVERRIDE. PROGRAMMING SHALL BE UNDERTAKEN BY THE CONTRACTOR WHO SHALL ADVISE ON THE OPERATION OF THE SYSTEM.

PROVISION OF SECURE HOUSING FOR THE AUTOMATIC IRRIGATION CONTROLLER TO BE LOCATED IN ASSOCIATION WITH THE LANDSCAPE CONTRACTOR AND LOCATION CONFIRMED BY THE SUPERINTENDENT. WIRING TO CONNECT REMOTE SOLENOID LOCATIONS IS TO BE PROVIDED. THE CONTROLLER SHALL BE LOCATED IN A DRY PLACE, PROTECTED FROM THE WEATHER, AND ALL CABLE CONNECTIONS SHALL BE MADE WITH WATERPROOF CONNECTORS.

WATER SUPPLY POINTS TO BE SUPPLIED BY BUILDER.

IT SHALL BE THE CONTRACTOR'S RESPONSIBILITY TO ENSURE AND GUARANTEE SATISFACTORY OPERATION OF THE IRRIGATION SYSTEM.

SATISFACTORY.

TREATED PINE TIMBER EDGING TIMBER EDGE: 100 X 25MM CCA TREATED RADIATA PINE TIMBER STAKES: 50 X 50 X 500MM CCA TREATED RADIATA PINE-SHARPENED AT ONE END. INSTALL IN LOCATIONS SHOWN ON THE DRAWINGS FLUSH TO FINISHED SURFACE LEVELS.

TURF TURF ALL LANDSCAPE AREAS AS SHOWN ON THE LANDSCAPE DRAWINGS. TURF IS TO HAVE AN EVEN THICKNESS OF NOT LESS THAN 25MM. OBTAIN TURF FROM AN APPROVED GROWER. FURNISH A WARRANTY FROM THE GROWER THAT THE TURF IS FREE FROM WEEDS AND OTHER FOREIGN MATTER. DELIVER TURF TO THE SITE WITHIN 24 HOURS OF BEING CUT, AND LAY IT WITHIN 24 HOURS OF BEING DELIVERED.

TO PREPARE GRADED AREAS TO RECEIVE TURF, EXCAVATE THE AREA AND CULTIVATE SO AS TO ALLOW FOR IMPORTING OF 100MM OF TURF UNDERLAY SOIL. REMOVE ALL STONES OVER 50MM Ø AND REMOVE ALL WEEDS AND FOREIGN MATTER. SPREAD SOIL MIX A.B.S TO A DEPTH OF 100MM AND GRADE TO APPROPRIATE LEVELS TO ACHIEVE GENERAL EVEN GRADES TO DRAINAGE OUTLETS INSTALLED BY OTHERS.

LAY THE TURF ALONG THE LAND CONTOURS WITH STAGGERED, CLOSE BUTTED JOINTS, SO THAT THE FINISHED TURF SURFACE IS FLUSH WITH ADJACENT FINISHED SURFACES OF PAVING AND THE LIKE. AS SOON AS PRACTICABLE AFTER LAVING, ROLL THE TURF WITH A ROLLER WEIGHING NOT MORE THAN 90KG PER METRE OF WIDTH FOR SANDY OR LIGHT SOILS.

WATER AS NECESSARY TO KEEP THE SOIL MOIST TO A DEPTH OF 100MM. PROTECT NEWLY TURFED AREAS AGAINST TRAFFIC UNTIL GRASS IS ESTABLISHED. FERTILISE TWO WEEKS AFTER LAYING FERTILISE A.B.S.

'TOP DRESS' THE TURF WHEN IT IS ESTABLISHED TO A DEPTH OF 10MM WITH COARSE WASHED RIVER SAND. RUB THE DRESSING WELL INTO THE JOINTS AND CORRECT ANY UNEVENNESS IN THE TURF SURFACES.

LANDSCAPE MAINTENANCE PROGRAM

MAINTENANCE SHALL MEAN THE CARE AND MAINTENANCE OF THE LANDSCAPE WORKS BY ACCEPTED HORTICULTURAL PRACTICE AS RECTIFYING ANY DEFECTS THAT BECOME APPARENT IN THE LANDSCAPE WORKS UNDER NORMAL USE. THIS SHALL INCLUDE, BUT SHALL NOT BE LIMITED TO, WATERING, MOWING, FERTILISING, RESEEDING, RETURFING, WEEDING, PEST AND DISEASE CONTROL, STAKING AND TYING, REPLANTING, CULTIVATION, PRUNING, AERATING, RENOVATING, TOP DRESSING, MAINTAINING THE SITE IN A NEAT AND TIDY CONDITION AS FOLLOWS:-

GENERA

THE LANDSCAPE CONTRACTOR SHALL MAINTAIN THE LANDSCAPE WORKS FOR THE TERM OF THE MAINTENANCE (OR PLANT ESTABLISHMENT) PERIOD TO THE SATISFACTION OF THE COUNCIL. THE LANDSCAPE CONTRACTOR SHALL ATTEND TO THE SITE ON A WEEKLY BASIS. THE MAINTENANCE PERIOD SHALL COMMENCE AT PRACTICAL COMPLETION AND CONTINUE FOR A PERIOD OF TWENTY SIX (26) WEEKS.

WATERING GRASS, TREES AND GARDEN AREAS SHALL BE WATERED REGULARLY SO AS TO ENSURE CONTINUOUS HEALTHY GROWTH. BUBBISH REMOVAL

DURING THE TERM OF THE MAINTENANCE PERIOD THE LANDSCAPE CONTRACTOR SHALL REMOVE RUBBISH THAT MAY OCCUR AND REOCCUR THROUGHOUT THE MAINTENANCE PERIOD. THIS WORK SHALL BE CARRIED OUT REGULARLY SO THAT AT WEEKLY INTERVALS THE AREA MAY BE OBSERVED IN A COMPLETELY CLEAN AND TIDY CONDITION.

REPLACEMENTS THE LANDSCAPE CONTRACTOR SHALL REPLACE ALL PLANTS THAT ARE MISSING, UNHEALTHY OR DEAD AT THE LANDSCAPE CONTRACTOR'S COST. REPLACEMENTS SHALL BE OF THE SAME SIZE, QUALITY AND SPECIES AS THE PLANT THAT HAS FAILED UNLESS OTHERWISE DIRECTED BY THE LANDSCAPE ARCHITECT. REPLACEMENTS SHALL BE MADE ON A CONTINUING BASIS NOT EXCEEDING TWO (2) WEEKS AFTER THE PLANT HAS DIED OR IS SEEN TO BE MISSING.

STAKES AND TIES THE LANDSCAPE CONTRACTOR SHALL REPLACE OR ADJUST PLANT STAKES. AND TREE GUARDS AS NECESSARY OR AS DIRECTED BY THE LANDSCAPE ARCHITECT. REMOVE STAKES AND TIES AT THE END OF THE MAINTENANCE PERIOD IF SO DIRECTED.

PRUNING TREES AND SHRUBS SHALL BE PRUNED AS DIRECTED BY THE LANDSCAPE ARCHITECT. PRUNING WILL BE DIRECTED AT THE MAINTENANCE OF THE DENSE FOLIAGE OR MISCELLANEOUS PRUNING AND BENEFICIAL TO THE CONDITION OF THE PLANTS. ANY DAMAGED GROWTH SHALL BE PRUNED. ALL PRUNED MATERIAL SHALL BE REMOVED FROM THE SITE.

MULCHED SURFACES ALL MULCHED SURFACES SHALL BE MAINTAINED IN A CLEAN AND TIDY CONDITION AND BE REINSTATED IF NECESSARY TO ENSURE THAT A DEPTH OF 75MM IS MAINTAINED. ENSURE MULCH IS KEPT CLEAR OF PLANT STEMS AT ALL TIMES.

PEST AND DISEASED CONTROL THE LANDSCAPE CONTRACTOR SHALL SPRAY AGAINST INSECT AND FUNGUS INFESTATION WITH ALL SPRAYING TO BE CARRIED OUT IN ACCORDANCE WITH THE MANUFACTURER'S DIRECTIONS. REPORT ALL INSTANCES OF PESTS AND DISEASES (IMMEDIATELY THAT THEY ARE DETECTED) TO THE LANDSCAPE ARCHITECT.

GRASS AND TURF AREAS THE LANDSCAPE CONTRACTOR SHALL MAINTAIN ALL GRASS AND TURF AREAS BY WATERING, WEEDING, DRESSING, ROLLING, MOWING, TRIMMING OR OTHER OPERATIONS AS NECESSARY, SEED AND TURF SPECIES SHALL BE THE SAME AS THE ORIGINAL SPECIFIED MIXTURE, GRASS AND TURF AREAS SHALL BE SPRAYED WITH APPROVED SELECTIVE HERBICIDE AGAINST BROAD LEAFED WEEDS AS REQUIRED BY THE LANDSCAPE ARCHITECT AND IN ACCORDANCE WITH THE MANUFACTURER'S DIRECTIONS, GRASS AND TURF AREAS SHALL BE FERTILISED ONCE A YEAR IN AUTUMN WITH "DYNAMIC LIFTER" FOR LAWNS AT A RATE OF 20KG PER 100M2. FERTILISER SHALL BE WATERED IN IMMEDIATELY AFTER APPLICATION. IRREGULARITIES IN THE GRASS AND TURF SHALL BE WATERED IN IMMEDIATELY AFTER APPLICATION. GRASS AND TURF AREAS SHALL BE KEPT MOWN TO MAINTAIN A HEALTHY AND VIGOROUS SWARD. MOWING HEIGHT: 30-50MM.

WEED ERADICATION

ERADICATE WEEDS BY ENVIRONMENTALLY ACCEPTABLE METHODS USING A NON-RESIDUAL GLYPHOSATE HERBICIDE (EG. 'ROUNDUP') IN ANY OF ITS REGISTERED FORMULAE, AT THE RECOMMENDED MAXIMUM RATE. REGULARLY REMOVE BY HAND, WEED GROWTH THAT MAY OCCUR OR RECUR THROUGHOUT GRASSED, PLANTED AND MULCHED AREAS. REMOVE WEED GROWTH FROM AN AREA 750MM DIAMETER AROUND THE BASE OF TREES IN GRASSED AREAS. CONTINUE ERADICATION THROUGHOUT THE COURSE OF THE WORKS AND DUBING THE MAINTENANCE PERIOD.

SOIL SUBSIDENCE ANY SOIL SUBSIDENCE OR EROSION WHICH MAY OCCUR AFTER THE SOIL FILLING AND PREPARATION OPERATIONS SHALL BE MADE GOOD BY THE LANDSCAPE CONTRACTOR AT NO COST TO THE CLIENT.



AFTER THE SYSTEM HAS BEEN INSTALLED TO THE SATISFACTION OF THE SUPERINTENDENT. THE INSTALLATION SHALL BE TESTED UNDER KNOWN WORKING CONDITIONS. ACCEPTANCE OF THE INSTALLED PLANT AND EQUIPMENT SHALL BE SUBJECT TO THESE BEING

34-42 EAST STREET GRANVILLE

LANDSCAPE S4.55 MODIFICATION





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